

THIS DOCUMENT HAS BEEN DIGITALLY SIGNED AND SEALED BY:

James Fritz Brogdon, PE Digitally signed by: James Fritz Brogdon, PE DN; CN = James Fritz Brogdon, PE email = fritz.brogdon@arcadis.com C = US O = Arcadis, Inc. OU = Senior Transportation Engineer Date: 2025.01.09 12:07:15 -05'00'

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ARCADIS U.S. INC. 1210 PREMIER DRIVE, SUITE 200 CHATTANOOGA, TN

JAMES FRITZ BROGDON, P.E. NO. 106940

THE ABOVE NAMED PROFESSIONAL ENGINEER SHALL BE RESPONSIBLE FOR THE FOLLOWING SHEETS IN ACCORDANCE OF TENN. CODE ANN. §62-2-306.

SHEET NAME	SHEET NO.
SIGNATURE SHEET	ROADWAY-SIGN2
ROADWAY INDEX AND STANDARD ROADWAY DRAWINGS	1A
ESTIMATED ROADWAY QUANTITIES	2

YEAR	PROJECT NO.	SHEET NO.
2025	NH/HSIP-34(136)	ROADWAY-SIGN2

STATE OF TENNESSEE

DEPARTMENT OF TRANSPORTATION

SIGNATURE SHEET



THIS DOCUMENT HAS BEEN DIGITALLY SIGNED AND SEALED BY:

James Fritz Brogdon, PEDN: CN = James Fritz Brogdon, PE email = fritz.

Transportation Engineer
Date: 2024.11.22 15:27:39 -05'00'

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JAMES FRITZ BROGDON, P.E. NO. 106940

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SHEET NAME	SHEET NO.
SIGNATURE SHEET	. ROADWAY-SIGN1
TITLE SHEET	. 1
ROADWAY INDEX AND STANDARD ROADWAY DRAWINGS	. 1A
STANDARD TRAFFIC OPERATIONS DRAWINGS	. 1A1
ESTIMATED ROADWAY QUANTITIES	. 2
TYPICAL SECTIONS	. 2B
TYPICAL SECTIONS AND PAVEMENT SCHEDULE	. 2B1
GENERAL NOTES	. 2C
SPECIAL NOTES	. 2D
ENVIRONMENTAL NOTES	. 2E
EROSION PREVENTION AND SEDIMENT CONTROL NOTES	. 2E1
TABULATED QUANTITIES	. 2F
UTILITY NOTES AND UTILITY OWNERS	. 3
PAVEMENT EDGE DROP-OFF NOTES FOR TRAFFIC CONTROL	. 4

YEAR	PROJECT NO.	SHEET NO.
2025	NH/HSIP-34(136)	ROADWAY-SIGN1

STATE OF TENNESSEE DEPARTMENT OF TRANSPORTATION

> SIGNATURE SHEET

THIS PROJECT TO BE BRACKETED WITH:

WASHINGTON CO. SR-34 PIN: 134049.00

# STATE OF TENNESSEE DEPARTMENT OF TRANSPORTATION BUREAU OF ENGINEERING

# **SULLIVAN COUNTY**

SR-34 (US-11E):

FROM NEAR HOLSTON RIVER

TO NEAR BEAVER CREEK
RESURFACE & SAFETY

411D AND MILLING, GUARDRAIL, AND PAVEMENT MARKINGS


STATE HIGHWAY NO. 34 F.A.H.S. NO. 11E, 19W

82S034-F8-004 82S034-F3-004 END PROJECT NO. NH/HSIP-34(136) RESURFACE & SAFETY

L.M. 11.50

82S034-F8-004 82S034-F3-004 BEGIN PROJECT NO. NH/HSIP-34(136) RESURFACE & SAFETY

L.M. 6.10

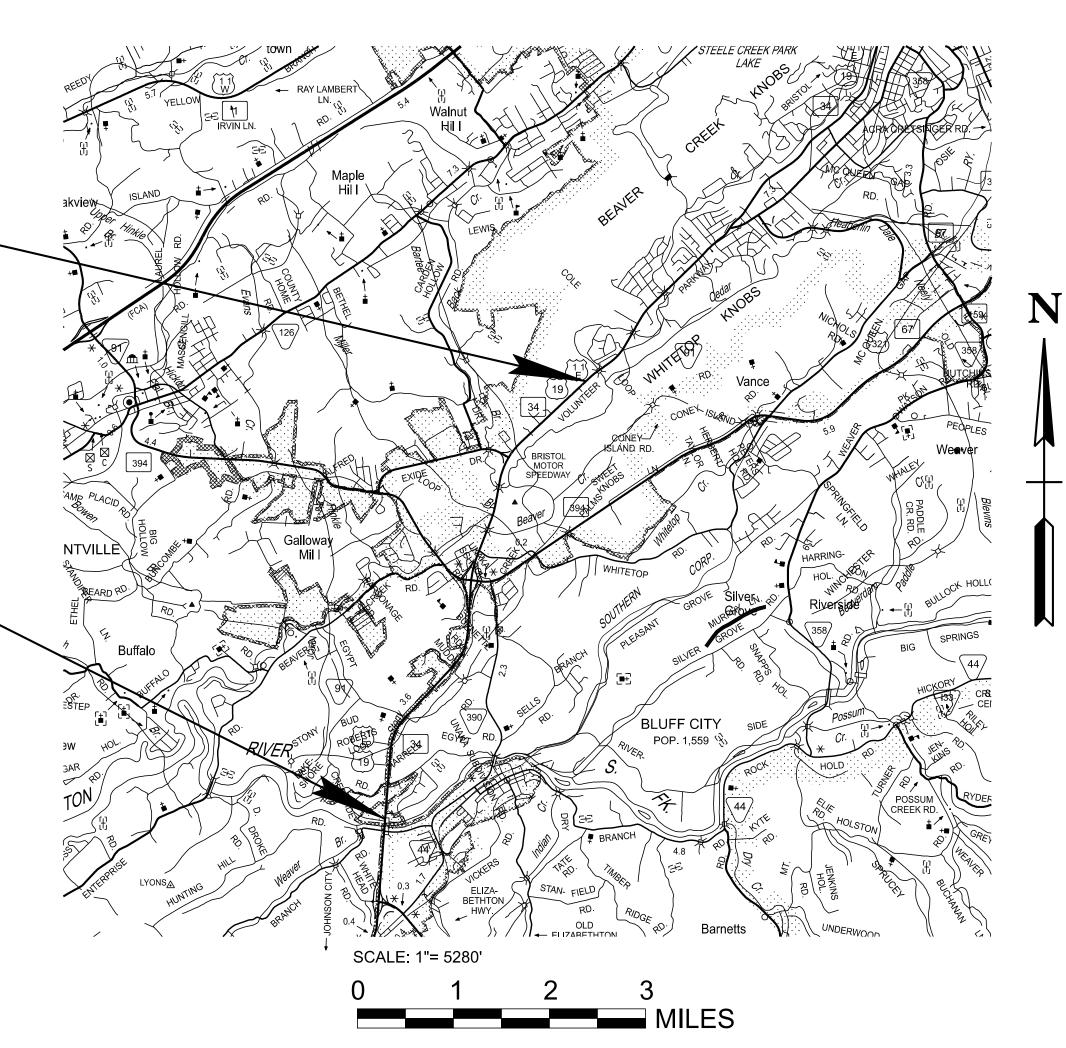

TOTAL LANE MILES RESURFACED 21.85 MILES

5.40 MILES

PROJECT LENGTH

SPECIAL NOTES

PROPOSALS MAY BE REJECTED BY THE COMMISSIONER IF ANY OF THE UNIT PRICES CONTAINED THEREIN ARE OBVIOUSLY UNBALANCED, EITHER EXCESSIVE OR BELOW THE REASONABLE COST ANALYSIS VALUE.

THIS PROJECT TO BE CONSTRUCTED UNDER THE STANDARD SPECIFICATIONS OF THE TENNESSEE DEPARTMENT OF TRANSPORTATION DATED JANUARY 1, 2021 AND ADDITIONAL SPECIFICATIONS AND SPECIAL PROVISIONS CONTAINED IN THE PLANS AND IN THE PROPOSAL CONTRACT.

TDOT PROJECT MANAGER 1: ERIC WILSON, P.E.

DESIGNER: ADAM GRAVITT

P.E. NO. : 98013-4203-04 (DESIGN)

PIN NO. <u>131615.00</u>

LSON, P.E.

CHECKED BY: <u>JAMES FRITZ BROGDAN, P.E.</u>

DOES THIS PROJECT QUALIFY FOR UTILITY CHAPTER 86


WORK ZONE SIGNIFICANCE DETERMINATION

SIGNIFICANT

YES


NO X

<	TENNI	YEAR	SHEET NO.
	TENN.	2025	1
	FED. AID PROJ. NO.	NH/HSIP-34(136)	
`	STATE PROJ. NO.	82S034-F3-004, 82S034-F8-004	

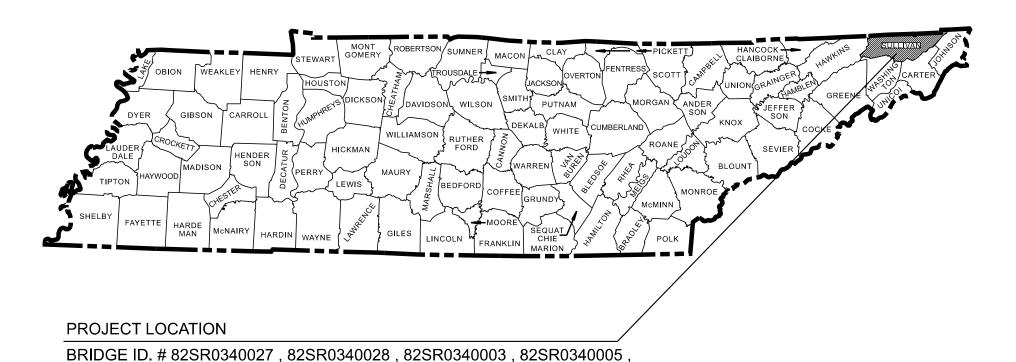

NO EXCLUSIONS

82SR0340007, 82SR0340008

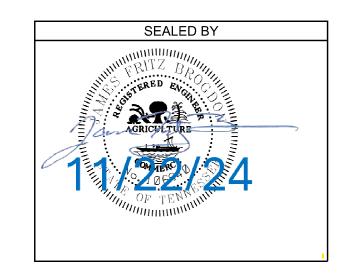

APPROVED:

WILL REID, CHIEF ENGINEER

\_..\_

HOWARD H. ELEY COMMISSIONER

SULLIVAN TRAF	FIC DATA
ADT (2025)	17690
POSTED SPEED	
LM 6.10 - LM 8.92	55 MPH
LM 8.92 - LM 11.50	45 MPH

U.S. DEPARTMENT OF TRANSPO	ORTATION
FEDERAL HIGHWAY ADMINIST	RATION
APPROVED:	
DIVISION ADMINISTRATOR	 Date

# **ROADWAY INDEX**

# STANDARD ROADWAY DRAWINGS

DWG.

REV.

TYPE	YEAR	PROJECT NO.	SHEET NO.	
RESURF.	2025	NH/HSIP-34(136)	1A	

REV. 01/09/25 : ADDED SHEET ROADWAY-SIGN2 TO ROADWAY INDEX.

SHEET NAME	SHEET NO.
SIGNATURE SHEET	ROADWAY-SIGN1
SIGNATURE SHEET	ROADWAY-SIGN2
TITLE SHEET	1
ROADWAY INDEX AND STANDARD ROADWAY DRAWINGS	1A
STANDARD TRAFFIC OPERATIONS DRAWINGS	1A1
ESTIMATED ROADWAY QUANTITIES	2
TYPICAL SECTIONS	2B
TYPICAL SECTIONS AND PAVEMENT SCHEDULE	2B1
GENERAL NOTES	2C
SPECIAL NOTES	2D
ENVIRONMENTAL NOTES	2E
EROSION PREVENTION AND SEDIMENT CONTROL NOTES	2E1
TABULATED QUANTITIES	2F
UTILITY NOTES AND UTILITY OWNERS	3
PAVEMENT EDGE DROP-OFF NOTES FOR TRAFFIC CONTRO	DL 4
*CURB RAMP REFERENCE SHEETS	27-33
NOTE: THE ALPHABETICAL LETTERS "I", "O" & "Q" ARE NOT	USED IN

#### NO PROJECT COMMITMENT SHEET INCLUDED IN THIS SET OF PLANS

NUMBERING OF SHEETS.

\* REFERENCE SHEETS ARE FROM CURB RAMP CONTRACT, PIN 133441.01 PROVIDED BY OTHERS.

STANDAF LEGENDS		VAY TITLE SHEET, ABBREVIATIONS, AND
RD-TP-1	10-01-24	STANDARD ROADWAY DRAWINGS TITLE SHEET
RD-A-1	02-20-20	STANDARD ABBREVIATIONS A THROUGH L
RD-A-2		STANDARD ABBREVIATIONS M THROUGH Z
RD-L-1	02-20-20	STANDARD LEGEND
RD-L-1A		STANDARD LEGEND
ROADWA	Y DESIGN	STANDARDS
RD11-SE-1		TRANSITION AND CROSS SLOPE DETAILS
RD11-SE-2		SUPERELEVATION TRANSITION DETAILS FOR UNDIVIDED ROADWAYS
RD11-SE-2A		SUPERELEVATION TRANSITION SECTIONS FOR UNDIVIDED ROADWAYS
RD11-SE-3		SUPERELEVATION TRANSITION DETAILS FOR DIVIDED ROADWAYS
RD11-SE-3A		SUPERELEVATION TRANSITION SECTIONS FOR DIVIDED ROADWAYS
RD11-LR-1		MINIMUM RUNOFF LENGTHS (LR) FOR URBAN HIGHWAYS
RD11-LR-2		MINIMUM RUNOFF LENGTHS (LR) FOR RURAL HIGHWAYS

**DESCRIPTION** 

#### SAFETY DESIGN AND GUARDRAILS

DWG.

REV.


S-CZ-1	06-28-19	CLEAR ZONE CRITERIA
S-PL-1	03-01-23	SAFETY PLAN FOR BARRIER LENGTH OF NEED
S-PL-1A	03-01-23	SAFETY PLAN FOR BARRIER LENGTH OF NEED (FOR RIGID OBJECTS)
S-PL-1B	03-01-23	SAFETY PLAN FOR BARRIER LENGTH OF NEED ON CURVED ROADWAYS
S-PL-3	03-01-23	SAFETY PLAN MINIMUM INSTALLATION AT BRIDGE ENDS
S-PL-5	06-28-19	SAFETY PLAN FOR BRIDGE ENDS IN MEDIANS
S-PL-6	07-30-24	SAFETY PLAN SAFETY HARDWARE PLACEMENT ON OUTSIDE EDGE
S-PL-6A	06-28-19	SAFETY PLAN SAFETY HARDWARE PLACEMENT IN MEDIAN
S-GR31-1	06-15-21	GUARDRAIL DETAILS
S-GRS-4	05-04-22	SPECIAL CASE GUARDRAIL HEIGHT TRANSITION DETAIL
S-GRT-2	06-28-19	TYPE 20 CHARDDAIL END TERMINAL
	00 20 10	TYPE 38 GUARDRAIL END TERMINAL
S-GRT-2P	10-16-20	EARTH PAD FOR TYPE 38 AND TYPE 21 TERMINAL
S-GRT-2P S-GRT-2R		
	10-16-20	EARTH PAD FOR TYPE 38 AND TYPE 21 TERMINAL EARTH PAD FOR TYPE 38 AND TYPE 21 TERMINAL
S-GRT-2R	10-16-20 06-28-19	EARTH PAD FOR TYPE 38 AND TYPE 21 TERMINAL (RETROFIT)
S-GRT-2R S-GRT-3	10-16-20 06-28-19	EARTH PAD FOR TYPE 38 AND TYPE 21 TERMINAL EARTH PAD FOR TYPE 38 AND TYPE 21 TERMINAL (RETROFIT) TYPE 21 GUARDRAIL END TERMINAL

DESIGN -	DESIGN - TRAFFIC CONTROL			
T-M-1	06-28-19	DETAILS OF PAVEMENT MARKINGS FOR CONVENTIONAL ROADS AND MARKING ABBREVIATIONS		
T-M-2	01-09-24	DETAILS OF PAVEMENT MARKINGS FOR CONVENTIONAL ROADS		
T-M-3	07-07-23	MARKING STANDARDS FOR TRAFFIC ISLANDS, PAVED SHOULDERS AND MEDIANS FOR CONVENTIONAL ROADS		
T-M-4	07-17-20	STANDARD INTERSECTION PAVEMENT MARKINGS		
T-M-15	06-28-19	ASPHALT SHOULDER RUMBLE STRIP INSTALLATION DETAILS FOR INTERSTATE AND ACCESS CONTROLLED ROUTES		
T-M-15A	06-28-19	ASPHALT SHOULDER RUMBLE STRIP INSTALLATION DETAILS FOR NON-ACCESS CONTROLLED RURAL ROUTES		
T-WZ-10	04-02-12	ADVANCE ROAD WORK SIGNING ON HIGHWAYS AND FREEWAYS		
T-WZ-11	03-04-21	ONE LANE CLOSURE DETAIL ON DIVIDED HIGHWAYS		
T-WZ-12	03-04-21	ONE LANE CLOSURE DETAIL FOR BRIDGES ON DIVIDED HIGHWAYS		
T-WZ-FAB1		FLASHING YELLOW ARROW BOARD		
EROSION	EROSION PREVENTION AND SEDIMENT CONTROL			

**DESCRIPTION** 

#### EROSION PREVENTION AND SEDIMENT CONTROL

EC-STR-3B	06-15-21	SILT FENCE
EC-STR-3C	03-01-23	SILT FENCE WITH WIRE BACKING
EC-STR-3E	04-01-08	SILT FENCE FABRIC JOINING DETAILS
EC-STR-34	05-04-22	EROSION CONTROL BLANKET FOR SLOPE INSTALLATION

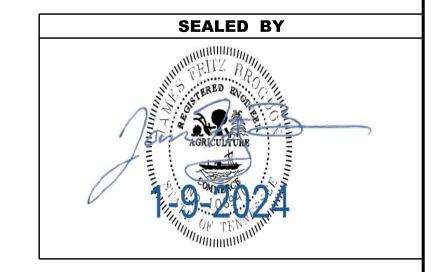


STATE OF TENNESSEE DEPARTMENT OF TRANSPORTATION

> **ROADWAY INDEX** AND STANDARD ROADWAY DRAWINGS

# STANDARD TRAFFIC OPERATIONS DRAWINGS

DWG.	REV.	DESCRIPTION
SIGNALS		
T-SG-2	06-27-16	LOOP LEAD-INS, CONDUIT AND PULL BOXES
T-SG-3	07-11-17	STANDARD NOTES AND DETAILS OF INDUCTIVE LOOPS

TYPE	YEAR	PROJECT NO.	SHEET NO.	
ESURF.	2025	NH/HSIP-34(136)	1A1	

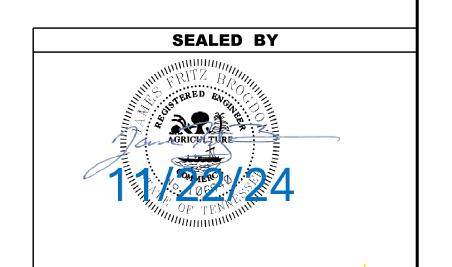

STATE OF TENNESSEE
DEPARTMENT OF TRANSPORTATION

STANDARD
TRAFFIC
OPERATIONS
DRAWINGS

TYPE	YEAR	PROJECT NO.	SHEET NO.	
RESURF.	2025	NH/HSIP-34(136)	2	


REV. 01/09/25 : REVISED QUANTITIES FOR ITEM NUMBERS 712-01 AND 717-01.

ITEM NO.	DESCRIPTION	UNIT	QUANTITY 82S034-F8-004	QUANTITY 82S034-F3-004	TOTAL QUANTITY
208-01.05	BROOMING & DEGRASSING SHOULDERS	L.M.	22		22
403-01	BITUMINOUS MATERIAL FOR TACK COAT (TC)	TON	126		126
411-01.07	ACS MIX (PG64-22) GRADING E SHOULDER	TON	4854		4854
411-01.21	LONGITUDINAL JOINT SEALANT	L.M.	28		28
411-02.10	ACS MIX(PG70-22) GRADING D	TON	14430		14430
411-12.02	SCORING SHOULDERS (NON-CONTINUOUS) (16IN WIDTH)	L.M.		11	11
415-01.01	COLD PLANING BITUMINOUS PAVEMENT	TON	19020		19020
705-02.10	GUARDRAIL TRANSITION 27IN TO 31IN	EACH		10	10
705-04.09	EARTH PAD FOR TYPE 38 GR END TREATMENT	EACH		8	8
705-04.10	EARTH PAD FOR GUARD RAIL END TREATMENT	EACH		2	2
705-06.20	TANGENT ENERGY ABSORBING TERM MASH TL-3	EACH		8	8
705-06.30	GR TERMINAL (ENERGY ABSORBING) MASH TL2	EACH		2	2
712-01	TRAFFIC CONTROL	LS	1		1
712-04.01	FLEXIBLE DRUMS (CHANNELIZING)	EACH	285		285
712-05.01	WARNING LIGHTS (TYPE A)	EACH	143		143
712-06	SIGNS (CONSTRUCTION)	S.F.	1849		1849
712-08.03	ARROW BOARD (TYPE C)	EACH	2		2
716-01.23	SNOWPLOWABLE RAISED PAVEMENT MARKERS (BI-DIR)(2 COLOR)	EACH	45		45
716-01.30	REMOVAL OF SNOWPLOWABLE REFLECTIVE MARKER	EACH	45		45
716-02.04	PLASTIC PAVEMENT MARKING(CHANNELIZATION STRIPING)	S.Y.		780	780
716-02.05	PLASTIC PAVEMENT MARKING (STOP LINE)	L.F.		372	372
716-02.06	PLASTIC PAVEMENT MARKING (TURN LANE ARROW)	EACH		57	57
716-02.09	PLASTIC PAVEMENT MARKING (LONGITUDINAL CROSS-WALK)	L.F.		1000	1000
716-03.04	PLASTIC WORD PAVEMENT MARKING (SCHOOL)	EACH		4	4
716-04.05	PLASTIC PAVEMENT MARKING (STRAIGHT ARROW)	EACH		1	1
716-04.12	PLASTIC PAVEMENT MARKING (YIELD LINE)	S.F.		72	72
716-04.14	PLASTIC PAVEMENT MARKING (LANE REDUCTION ARROW)	EACH		1	1
716-04.16	PLASTIC PAVEMENT MARKING (NOISE STRIP)	L.F.		60	60
716-05.20	PAINTED PAVEMENT MARKING (6" LINE)	L.M.	25		25
716-13.02	SPRAY THERMO PVMT MRKNG (60 mil) (6IN LINE)	L.M.	25		25
716-13.05	SPRAY THERMO PVMT MRKNG (60 mil) (6IN DOTTED LINE)	L.F.	1712		1712
717-01	MOBILIZATION	LS	1		1
730-14.02	SAW SLOT	L.F.	3500		3500
730-14.03	LOOP WIRE	L.F.	7000		7000

#### **FOOTNOTES**


- (1) INCLUDES <u>2210 TONS</u> FOR SR-394 CROSS-OVERS, TURN LANES, AND RAMPS, AND <u>30 TONS</u> FOR CITY STREETS AND COUNTY ROADS.
- (2) QUANTITY INCLUDES <u>4.9 LM</u> FOR OUTSIDE SHOULDER BETWEEN LM 6.10 LM 9.17.
  QUANTITY CALCULATED BY MULTIPLYING PROJECT LENGTH BY A FACTOR OF (60/75).
  QUANTITY ALSO INCLUDES <u>6.1 LM</u> FOR INSIDE SHOULDER BETWEEN LM 6.10 LM 9.17
  A CONTINUOUS APPLICATION SHOULD BE APPLIED TO THE INSIDE SHOULDER
- (3) INCLUDES <u>2190 TONS</u> FOR SR-394 CROSS-OVERS, TURN LANES, AND RAMPS, AND 29.7 TONS FOR COUNTY ROADS.
- (4) SEE SHEET NUMBER 2F FOR PROPOSED GUARDRAIL TABLE. INCLUDES THE COST OF REMOVAL OF THE EXISTING END TERMINALS.
- (5) INCLUDES ALL MATERIAL NECESSARY FOR THE CONSTRUCTION OF THE PAD AND ANY NECESSARY EPSC MEASURES.
- (6) TO BE BRACKETED WITH:
  WASHINGTON CO. SR-34
  PIN 134049.00
- (7) SEE SHEET NUMBER 2F FOR TRAFFIC CONTROL SIGN TABULATION BLOCK.
- (8) ANY DAMAGE INCURRED DURING THE REMOVAL SHALL BE REPAIRED AT THE CONTRACTOR'S EXPENSE AND TO THE SATIFACTION OF THE TDOT MANAGER
- (9) THE CONTRACTOR MAY ELECT TO SUBSTITUTE PREFORMED PLASTIC FOR THERMOPLASTIC. PREFORMED PLASTIC SHALL BE PAID FOR AT THE SAME UNIT PRICE AS BID FOR THERMOPLASTIC.
- (10) SEE SHEET NUMBER 2F FOR ADDITIONAL INFO.
- (11) TO BE USED FOR TEMPORARY STRIPING DURING THE MILLING OPERATION. NO PAYMENT WILL BE MADE FOR TEMPORARY STRIPING DURING PLACEMENT OF THE FINAL SURFACE (ON EITHER EXISTING SURFACE OR FINAL) COURSE DUE TO THE CONTRACTOR'S METHODS OF CONSTRUCTION.
- (12) SIGNAL DETECTION LOOPS SHALL BE INSTALLED BEFORE THE FINAL SURFACE IS APPLIED.


NOTE: THERE ARE NO UTILITY ADJUSTMENTS ON THIS PROJECT.

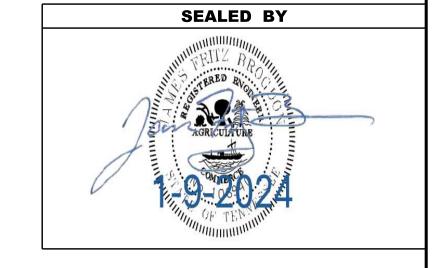


STATE OF TENNESSEE
DEPARTMENT OF TRANSPORTATION

ESTIMATED ROADWAY QUANTITIES

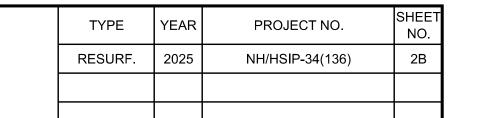

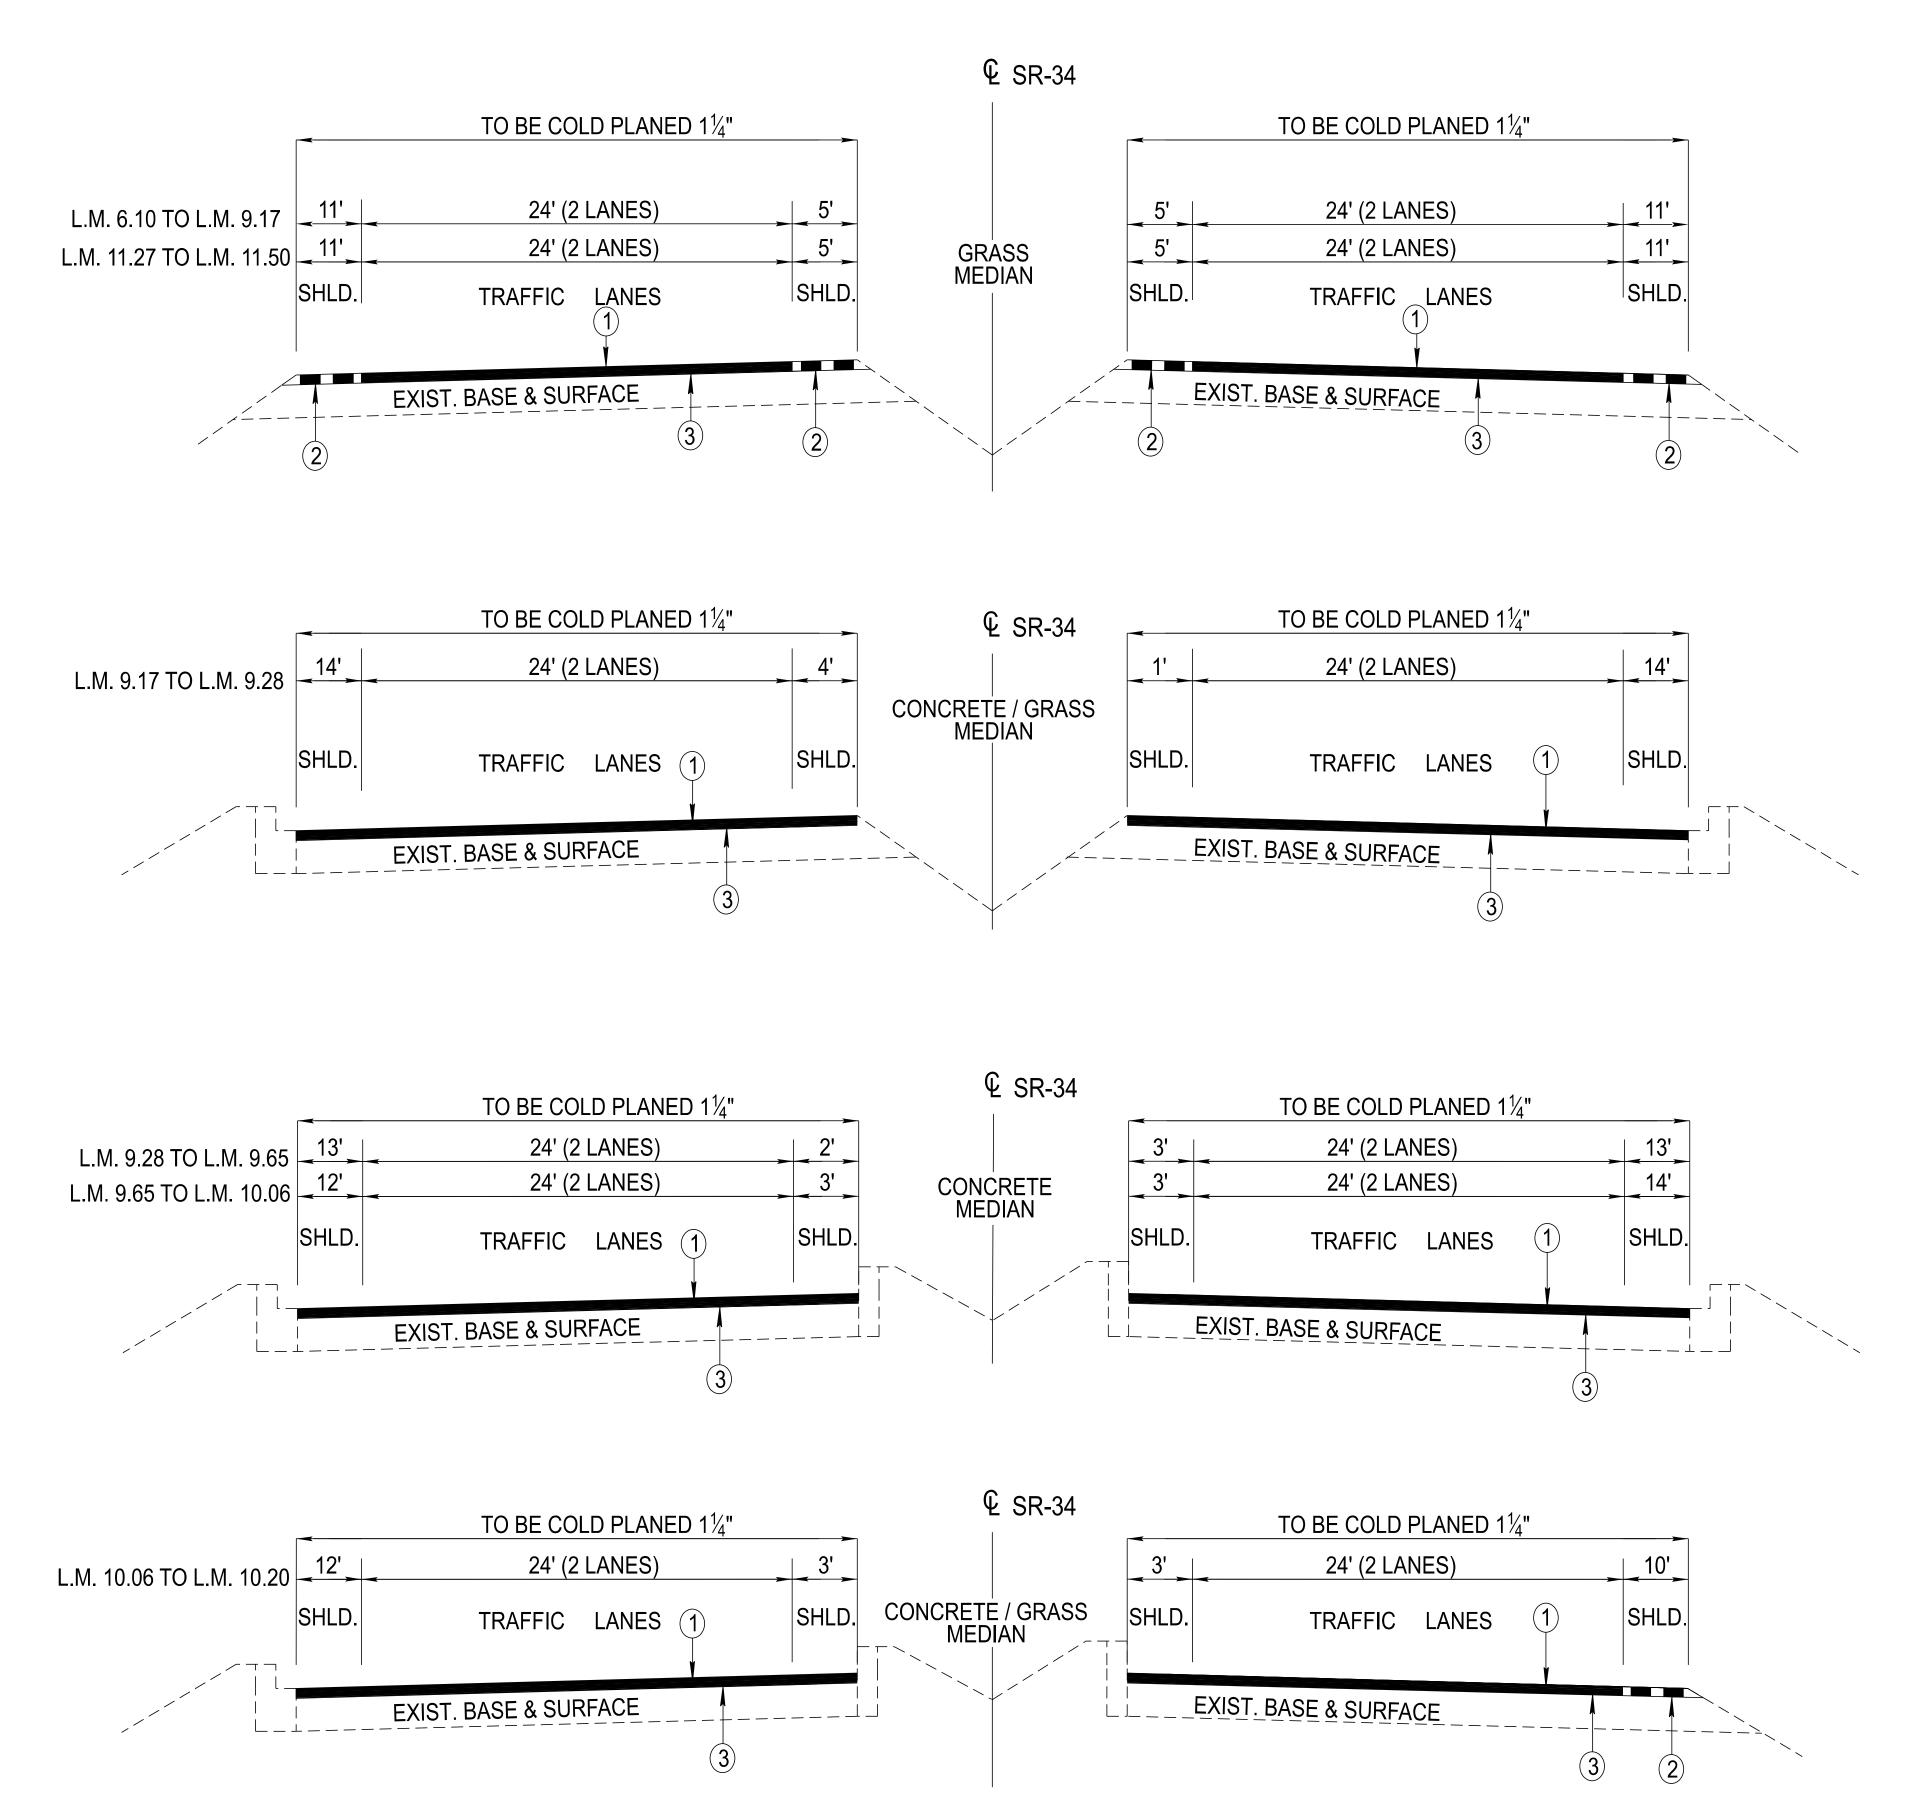


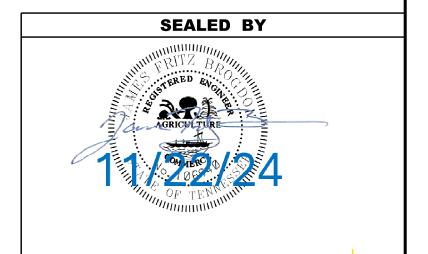



STATE OF TENNESSEE
DEPARTMENT OF TRANSPORTATION

TYPICAL SECTIONS

# SR-34 SULLIVAN COUNTY

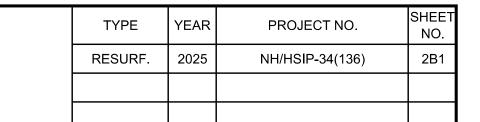

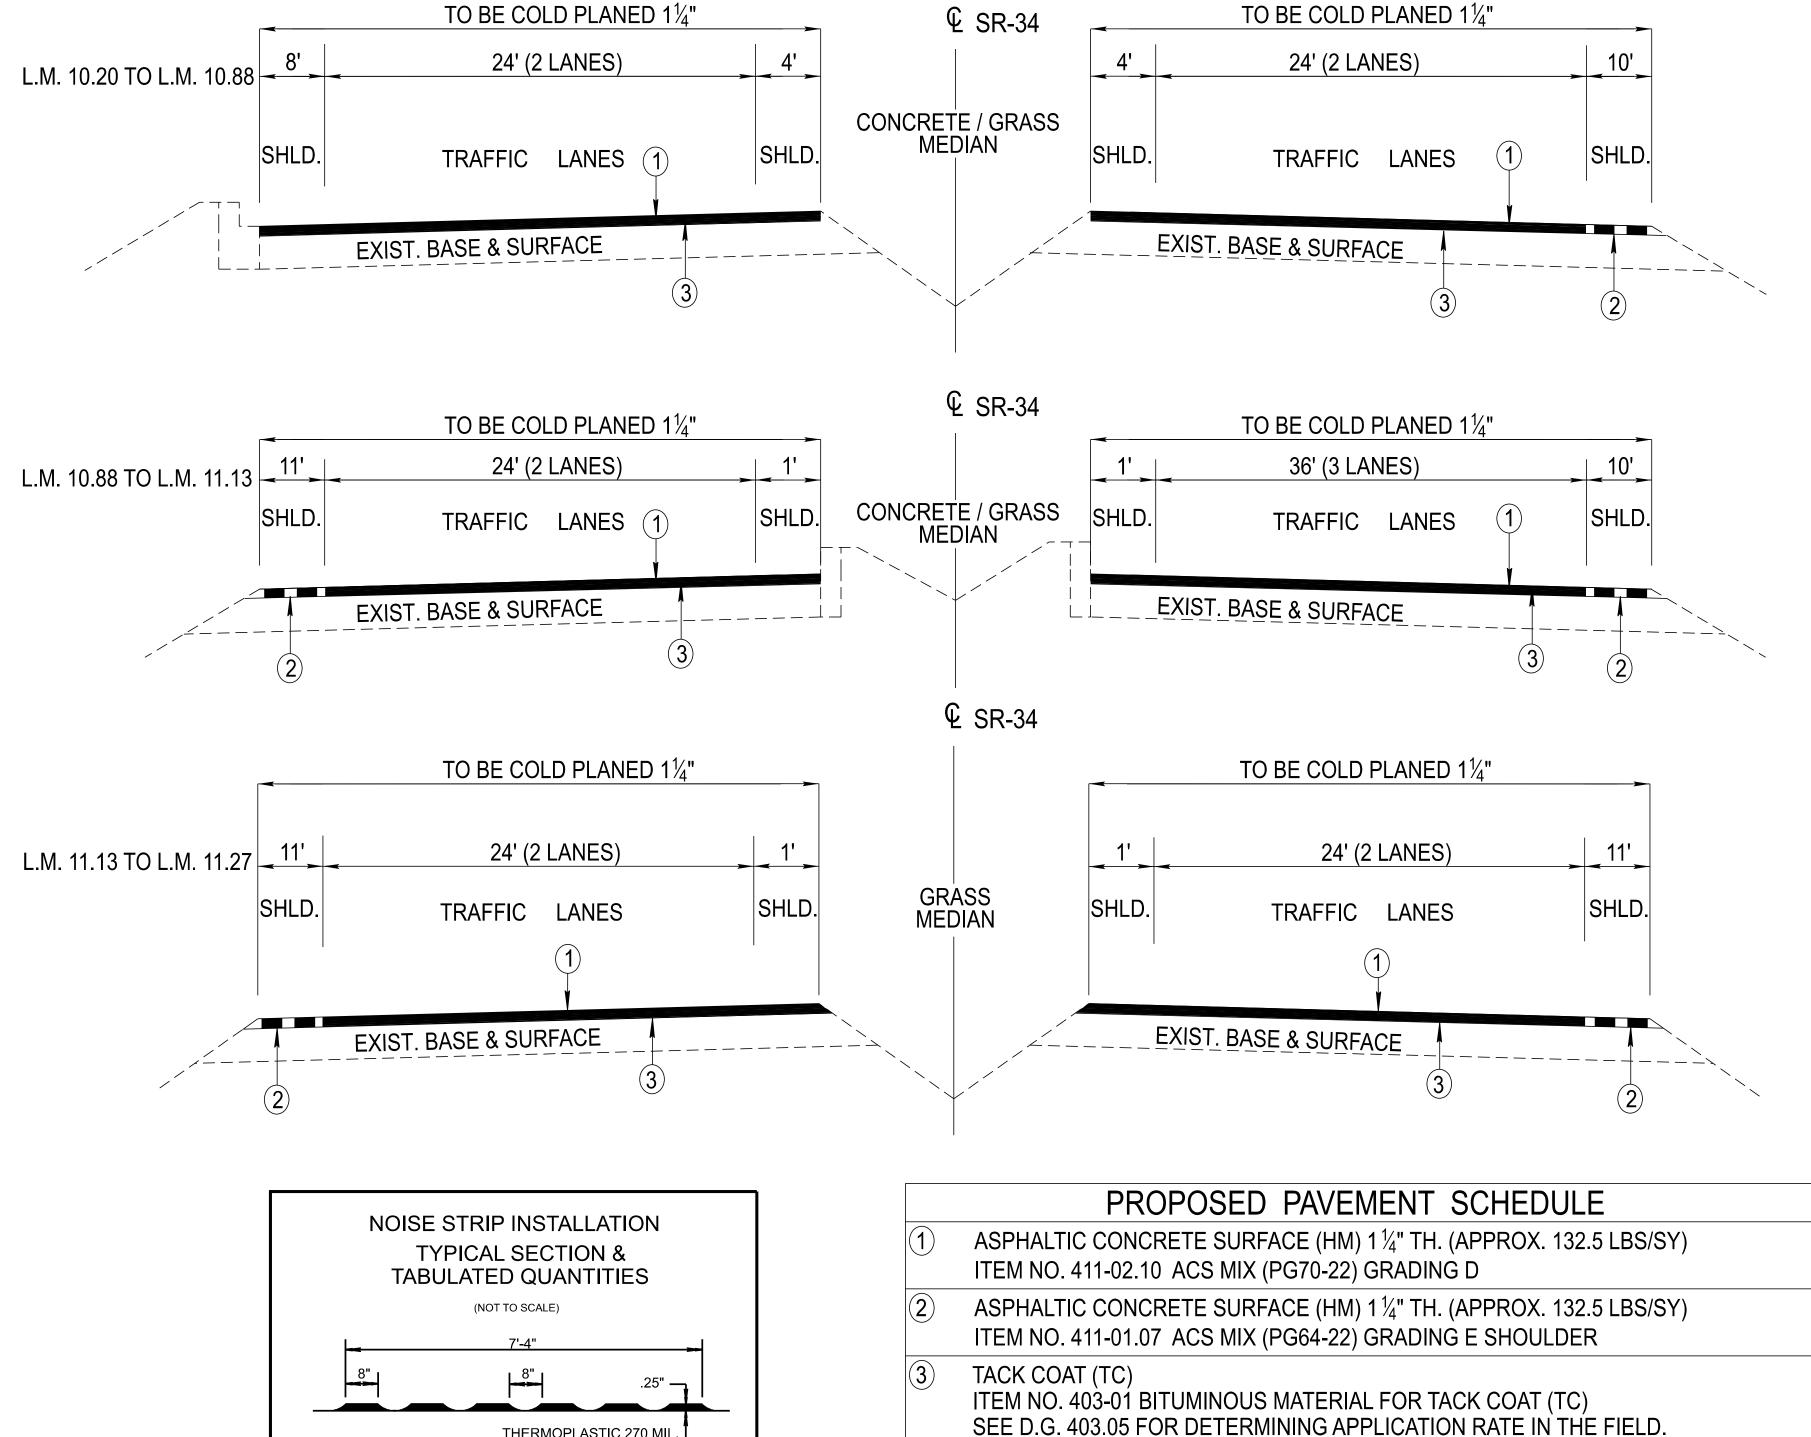

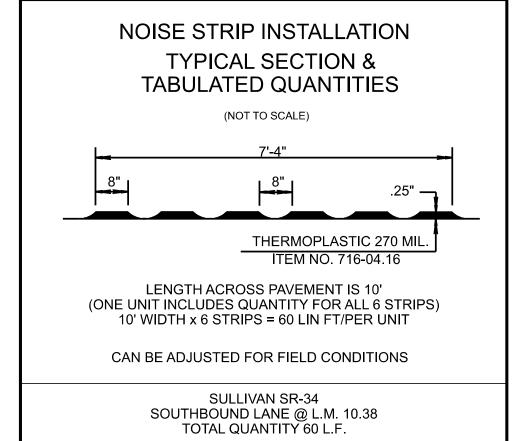

- - COLD PLANING 11/4" TH. (APPROX. 131.3 LBS/SY) ITEM NO. 415-01.01 COLD PLANING BITUMINOUS PAVEMENT


#### **BRIDGE NOTES:**

BRIDGE OVER SR-394 (L.M. 8.86) IS TO BE COLD PLANED  $1\frac{1}{4}$ " AND PAVED WITH  $1\frac{1}{4}$ " 411-02.10 ACS MIX (PG70-22) GRADING D ASPHALT AND 411-01.07 ACS MIX (PG64-22) GRADING E SHOULDER ASPHALT.

BRIDGE OVER BEAVER CREEK (L.M. 9.37) IS TO BE LEFT AS IS.

BRIDGE OVER BACK CREEK (L.M. 9.89) IS TO BE LEFT AS IS.

BRIDGE OVER BEAVER CREEK (L.M. 11.50) IS TO BE COLD PLANED  $1\frac{1}{4}$ " AND PAVED WITH  $1\frac{1}{4}$ " 411-02.10 ACS MIX (PG70-22) GRADING D ASPHALT AND 411-01.07 ACS MIX (PG64-22) GRADING E SHOULDER ASPHALT.

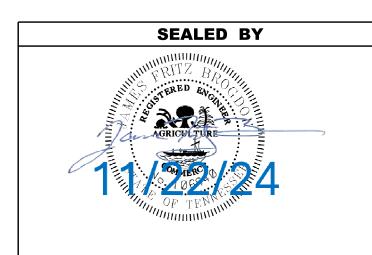

**STATE OF TENNESSEE DEPARTMENT OF TRANSPORTATION** 

TYPICAL SECTIONS AND PAVEMENT SCHEDULE

#### **GRADING**

- (1) ANY AREA THAT IS DISTURBED OUTSIDE LIMITS OF CONSTRUCTION DURING THE LIFE OF THIS PROJECT SHALL BE REPAIRED BY THE CONTRACTOR AT HIS EXPENSE.
- THE CONTRACTOR SHALL NOT DISPOSE OF ANY MATERIAL EITHER ON OR OFF STATE-OWNED R.O.W. IN A REGULATORY FLOOD WAY AS DEFINED BY THE FEDERAL EMERGENCY MANAGEMENT AGENCY (FEMA) WITHOUT APPROVAL BY FEMA. ALL MATERIAL SHALL BE DISPOSED OF IN UPLAND (NON-WETLAND) AREAS AND ABOVE ORDINARY HIGH WATER OF ANY ADJACENT WATERCOURSE. THIS DOES NOT ELIMINATE THE NEED TO OBTAIN ANY OTHER LICENSES OR PERMITS THAT MAY BE REQUIRED BY ANY OTHER FEDERAL, STATE OR LOCAL AGENCY.

#### **GUARDRAIL**

- (1) THE CONTRACTOR SHALL NOT REMOVE ANY SECTIONS OF EXISTING GUARDRAIL TO REWORK SHOULDERS OR FLATTEN SLOPES UNTIL THE ENGINEER CONCURS IN THE NECESSITY OF REMOVAL DUE TO CONSTRUCTION REQUIREMENTS AND THE APPROPRIATE WARNING DEVICES ARE INSTALLED. THE PROPOSED GUARDRAIL, INCLUDING ANY ANCHOR SYSTEM, SHALL BE INSTALLED QUICKLY TO MINIMIZE TRAFFIC EXPOSURE TO ANY HAZARD. NO PAYMENT WILL BE MADE FOR A SECTION OF PROPOSED GUARDRAIL, INCLUDING ANCHORS, UNTIL IT IS COMPLETE IN PLACE.
- (3) IF ANY APPROACH END OF A SECTION OF GUARDRAIL OR BRIDGE RAIL MUST TEMPORARILY BE LEFT INCOMPLETE AND EXPOSED TO TRAFFIC, THE CONTRACTOR SHALL USE TWO (2) TEMPORARY BARRICADES OR DRUMS WITH TYPE "A" LIGHTS AND ROUNDED END ELEMENTS AS MINIMUM MEASURES TO PROTECT TRAFFIC FROM THE HAZARD OF AN EXPOSED END. ALL COST OF FURNISHING AND INSTALLING TEMPORARY BARRICADES OR DRUMS WITH TYPE "A" LIGHTS TO DELINEATE GUARDRAIL END AND A TEMPORARY ROUNDED END ELEMENT SHALL BE INCLUDED IN THE COST OF THE PROPOSED GUARDRAIL END TERMINAL.

#### **MISCELLANEOUS**

- (2) THE CONTRACTOR SHALL BE REQUIRED TO REMOVE AND RESET MAILBOXES AND POSTS WHERE AND AS DIRECTED BY THE ENGINEER. COST TO BE INCLUDED IN PRICE BID FOR OTHER CONSTRUCTION ITEMS.
- (3) NOTHING IN THE GENERAL NOTES OR SPECIAL PROVISIONS SHALL RELIEVE THE CONTRACTOR FROM HIS RESPONSIBILITIES TOWARD THE SAFETY AND CONVENIENCE OF THE GENERAL PUBLIC AND THE RESIDENTS ALONG THE PROPOSED CONSTRUCTION AREA.

#### **PAVEMENT MARKINGS**

#### TEMPORARY PAVEMENT MARKINGS ON INTERMEDIATE LAYERS

TEMPORARY PAVEMENT LINE MARKINGS ON INTERMEDIATE LAYERS OF PAVEMENT SHALL BE REFLECTIVE TAPE OR REFLECTORIZED PAINT INSTALLED TO PERMANENT STANDARDS AT THE END OF EACH DAY'S WORK. SHORT, UNMARKED SECTIONS SHALL NOT BE ALLOWED. THESE MARKINGS WILL BE MEASURED AND PAID FOR UNDER ITEM NO. 716-05.20, PAINTED PAVEMENT MARKING (6" LINE), L.M.

#### FINAL PAVEMENT MARKING

- (5) THE CONTRACTOR WILL BE REQUIRED TO PERFORM THE FOLLOWING WORK:
  - a. SHOULDERS SHALL BE BROOMED AND DE-GRASSED AND MATERIAL SHALL BE PICKED UP AND REMOVED. THIS WILL BE PAID FOR UNDER ITEM NO. 208-01.05.
  - b. REMOVE ALL GARBAGE AND CONSTRUCTION DEBRIS FROM PROJECT. THE COST FOR THIS WILL BE INCLUDED IN THE PRICE BID FOR OTHER ITEMS OF CONSTRUCTION.
- (11) PERMANENT PAVEMENT LINE MARKINGS SHALL BE 6" SPRAY THERMOPLASTIC (60 mil) INSTALLED TO PERMANENT STANDARDS AT THE END OF EACH DAY'S WORK. SHORT UNMARKED SECTIONS SHALL NOT BE ALLOWED. PAVEMENT MARKINGS WILL BE MEASURED AND PAID FOR UNDER ITEM NO. 716-13.02, SPRAY THERMO PVMT MRKNG (60 mil) (6IN LINE), L.M. THE CONTRACTOR SHALL HAVE THE OPTION OF USING REFLECTORIZED PAINT INSTALLED TO PERMANENT STANDARDS AT THE END OF EACH DAY'S WORK AND THEN INSTALLING THE PERMANENT MARKINGS AFTER THE PAVING OPERATION IS COMPLETED. THE TEMPORARY MARKINGS FOR THE FINAL SURFACE WILL NOT BE MEASURED AND PAID FOR DIRECTLY, BUT THE COSTS ARE TO BE INCLUDED IN THE PRICE BID FOR THE PERMANENT MARKINGS.

#### SNOWPLOWABLE REFLECTIVE PAVEMENT MARKERS

20) REMOVE EXISTING SNOWPLOWABLE MARKERS PRIOR TO PAVING AND/OR COLD PLANING. REMOVE ALL ADHESIVES PRIOR TO PAVING. PATCH ANY HOLES OR DIVOTS RESULTING FROM THE REMOVAL OF A MARKER IN A MANNER WHICH ENSURES A UNIFORM PAVED SURFACE. PATCH WORK SHALL BE INCLUDED WITH COST OF OTHER ITEMS OF CONSTRUCTION.

#### **PAVEMENT**

#### **PAVING**

(2) THE CONTRACTOR SHALL BE REQUIRED TO COLD PLANE AND PAVE IN THE DIRECTION OF TRAFFIC.

#### **RESURFACING**

- (4) WHERE DIRECTED BY THE TDOT ENGINEER, THE CONTRACTOR SHALL BE REQUIRED TO SHAPE PUBLIC SIDE ROADS, BUSINESS ENTRANCES, AND PRIVATE DRIVES, AS WELL AS CLEANING OF EXISTING DRAINS BEFORE PLACING MATERIALS. ALL COSTS ARE TO BE INCLUDED IN THE PRICE BID FOR OTHER ITEMS OF CONSTRUCTION.
- (5) ALL PUBLIC SIDE ROADS SHALL BE PAVED ONE PAVER WIDTH THROUGH THE INTERSECTION AS A MINIMUM. A SATISFACTORY TRANSITION FROM THE NEW PAVEMENT TO THE EXISTING GRADE OF THE INTERSECTING PUBLIC ROAD OR BUSINESS ENTRANCE SHALL BE PROVIDED. SHOULD THE PAVEMENT OF THE INTERSECTING PUBLIC ROAD BE DISTRESSED, THE RESURFACING WIDTH MAY BE INCREASED TO THE NORMAL RIGHT OF WAY
- (6) PRIVATE DRIVEWAYS, FIELD ENTRANCES, AND BUSINESS ENTRANCES WILL BE RESURFACED A PAVER WIDTH (LANE WIDTH) AS A MINIMUM. A PAVEMENT TAPER TO TRANSITION THE NEW PAVEMENT SHALL BE REQUIRED, IT SHALL BE BASED ON AN ADDITIONAL ONE FOOT OF WIDTH PER ONE INCH DEPTH OF PAVEMENT. IF THE SHOULDER IS NARROW ENOUGH THAT THE SUM OF THE SHOULDER AND THE TRANSITION ARE LESS THAN A PAVER WIDTH, THE TRANSITION SHALL OCCUR WITHIN THE PAVER WIDTH. IF THE SUM OF THE SHOULDER AND THE TRANSITION IS GREATER THAN A PAVER WIDTH (LANE WIDTH), THE TRANSITION SHALL OCCUR OUTSIDE OF THE PAVER WIDTH.
- (7) ON CURB AND GUTTER SECTIONS, PUBLIC ROAD INTERSECTIONS SHALL BE RESURFACED TO THE END OF RADIUS. A SATISFACTORY TRANSITION FROM THE NEW PAVEMENT TO THE EXISTING GRADE OF THE INTERSECTING PUBLIC ROAD SHALL BE PROVIDED.
- (8) ON URBAN TYPICAL SECTIONS, (CURB AND GUTTER), RESIDENTIAL DRIVEWAYS AND BUSINESS ENTRANCES SHALL HAVE A MINIMUM WIDTH OF MATERIAL NOT LESS THAN ONE FOOT USED IN THE TRANSITION TO FEATHER THE PAVEMENT EDGE.
- (9) IN ALL CASES, THE LENGTH OF THE PAVEMENT TRANSITION, THE THICKNESS AND WIDTH OF THE RESURFACING AND ANY ADDITIONAL PAVEMENT MATERIALS SHALL BE AS DIRECTED BY THE TDOT ENGINEER.

#### SIGNING

(12) ALL SIGNS WHICH INTERFERE WITH CONSTRUCTION WILL BE RELOCATED OUTSIDE LIMITS OF CONSTRUCTION BY THE CONTRACTOR. UPON COMPLETION OF CONSTRUCTION, THE CONTRACTOR WILL RESTORE THE SIGNS TO ORIGINAL LOCATION. THE CONTRACTOR SHALL CHECK WITH THE REGIONAL TRAFFIC ENGINEER PRIOR TO MOVING ANY PERMANENT SIGNS.

#### TRAFFIC CONTROL DIRECTIONAL SIGNING

(7) WHEN EXISTING "TOURIST ORIENTED DIRECTIONAL SIGNS" (TODS) ARE ON NON-ACCESS CONTROLLED CONSTRUCTION PROJECTS, THE CONTRACTOR SHALL BE RESPONSIBLE FOR KEEPING THESE SIGNS IN FULL VIEW TO THE MOTORING PUBLIC DURING ALL PHASES OF CONSTRUCTION. ALL WORK IN MOVING THESE "TODS" AND TEMPORARY SUPPORTS ARE TO BE PAID FOR UNDER ITEM NO. 712-06, AS DIRECTED BY THE ENGINEER. NEW SUPPORTS AND SIGN FACE FOR FINAL LOCATION WILL BE PAID FOR UNDER OTHER ITEMS OF CONSTRUCTION.

#### **SIGNALIZATION**

- (1) EQUIPMENT AND INSTALLATION OF TRAFFIC SIGNALS SHALL COMPLY WITH TDOT STANDARD SPECIFICATIONS, SECTION 730.
- (6) SALVAGEABLE EQUIPMENT SHALL BECOME THE PROPERTY OF SULLIVAN COUNTY AND SHALL BE STOCKPILED AT A LOCATION DESIGNATED BY THE ENGINEER FOR PICKUP BY SULLIVAN COUNTY.
- (7) IF RESURFACING IS INCLUDED IN THE PROJECT, SIGNAL DETECTION LOOPS SHALL BE INSTALLED BEFORE THE FINAL SURFACE IS APPLIED.

- (11) THE PROJECT ENGINEER SHALL NOTIFY THE LOCAL GOVERNMENTAL AGENCY RESPONSIBLE FOR TRAFFIC CONTROL MAINTENANCE AT LEAST ONE DAY IN ADVANCE OF THE COLD PLANING ACTIVITY AT SIGNALIZED INTERSECTIONS WHERE DETECTOR LOOPS ARE ON THE PAVEMENT. THE MAINTAINING AGENCY WILL THEN BE RESPONSIBLE FOR DISCONNECTING THE LOOP DETECTORS AND MAKING ANY NECESSARY TIMING ADJUSTMENTS IN THE SIGNAL CONTROLLER PRIOR TO THE CONSTRUCTION.
- (13) LOOPS SHALL BE INSTALLED IN THE LEVELING COURSE IF A LEVELING COURSE IS PROVIDED.
- (14) LOOP REPLACEMENT SHALL BE IN ACCORDANCE WITH SECTION 730 OF THE STANDARD SPECIFICATIONS.

#### CONSTRUCTION WORK ZONE & TRAFFIC CONTROL

- (1) ADVANCED WARNING SIGNS SHALL NOT BE DISPLAYED MORE THAN FORTY-EIGHT (48) HOURS BEFORE PHYSICAL CONSTRUCTION BEGINS. SIGNS MAY BE ERECTED UP TO ONE WEEK BEFORE NEEDED, IF THE SIGN FACE IS FULLY COVERED.
- (2) IF THE CONTRACTOR MOVES OFF THE PROJECT, HE SHALL COVER OR REMOVE ALL UNNEEDED SIGNS AS DIRECTED BY THE ENGINEER. COSTS OF REMOVAL, COVERING, AND REINSTALLING SIGNS SHALL NOT BE MEASURED AND PAID FOR SEPARATELY, BUT ALL COSTS SHALL BE INCLUDED IN THE ORIGINAL UNIT PRICE BID FOR ITEM NO. 712-06, SIGNS (CONSTRUCTION) PER SQUARE FOOT.
- (3) A LONG TERM BUT SPORADIC USE WARNING SIGN, SUCH AS A FLAGGER SIGN, MAY REMAIN IN PLACE WHEN NOT REQUIRED PROVIDED THE SIGN FACE IS FULLY COVERED.
- (4) TRAFFIC CONTROL DEVICES SHALL NOT BE DISPLAYED OR ERECTED UNLESS RELATED CONDITIONS ARE PRESENT NECESSITATING WARNING.
- USE OF BARRICADES, PORTABLE BARRIER RAILS, AND DRUMS SHALL BE LIMITED TO THE IMMEDIATE AREAS OF CONSTRUCTION WHERE A HAZARD IS PRESENT. THESE DEVICES SHALL NOT BE STORED ALONG THE ROADWAY WITHIN THIRTY (30) FEET OF THE EDGE OF THE TRAVELED WAY BEFORE OR AFTER USE UNLESS PROTECTED BY GUARDRAIL, BRIDGE RAIL, AND/OR BARRIERS INSTALLED FOR OTHER PURPOSES FOR ROADWAYS WITH CURRENT ADT'S LESS THAN 1500 AND DESIGN SPEED OF LESS THAN 60 MPH. THIS DISTANCE SHALL INCREASE TO FORTY-FIVE (45) FEET FOR ROADWAYS WITH CURRENT ADT'S OF 1500 OR GREATER AND DESIGN SPEED OF 60 MPH OR GREATER OR ON THE OUTSIDE OF A HORIZONTAL CURVE. THESE DEVICES SHALL BE REMOVED FROM THE CONSTRUCTION WORK ZONE WHEN THE ENGINEER DETERMINES THEY ARE NO LONGER NEEDED. WHERE THERE IS INSUFFICIENT RIGHT-OF-WAY TO PROVIDE FOR THIS REQUIRED SETBACK, THE CONTRACTOR SHALL DETERMINE THE ALTERNATE LOCATIONS AND REQUEST THE ENGINEER'S APPROVAL TO USE THEM.
- THE CONTRACTOR SHALL NOT BE PERMITTED TO PARK ANY VEHICLES OR CONSTRUCTION EQUIPMENT DURING PERIODS OF INACTIVITY, WITHIN THIRTY (30) FEET OF THE EDGE OF PAVEMENT WHEN THE LANE IS OPEN TO TRAFFIC UNLESS PROTECTED BY GUARDRAIL, BRIDGE RAIL, AND/OR BARRIERS INSTALLED FOR OTHER PURPOSES FOR ROADWAYS WITH CURRENT ADT'S LESS THAN 1500 AND DESIGN SPEED OF LESS THAN 60 MPH. THIS DISTANCE SHALL BE INCREASED TO FORTY-FIVE (45) FEET FOR ROADWAYS WITH CURRENT ADT'S OF 1500 OR GREATER AND DESIGN SPEED OF 60 MPH OR GREATER OR ON THE OUTSIDE OF A HORIZONTAL CURVE. PRIVATELY OWNED VEHICLES SHALL NOT BE ALLOWED TO PARK WITHIN THIRTY (30) FEET OF AN OPEN TRAFFIC LANE AT ANY TIME UNLESS PROTECTED AS DESCRIBED ABOVE FOR ROADWAYS WITH CURRENT ADT'S LESS THAN 1500 AND DESIGN SPEED OF LESS THAN 60 MPH. THIS DISTANCE SHALL BE INCREASED TO FORTY-FIVE (45) FEET FOR ROADWAYS WITH CURRENT ADT'S OF 1500 OR GREATER AND DESIGN SPEED OF 60 MPH OR GREATER OR ON THE OUTSIDE OF A HORIZONTAL CURVE. WHERE THERE IS INSUFFICIENT RIGHT-OF-WAY TO PROVIDE FOR THIS REQUIRED SETBACK, THE CONTRACTOR SHALL DETERMINE THE ALTERNATE LOCATIONS AND REQUEST THE ENGINEER'S APPROVAL TO USE THEM.
- (7) ALL DETOUR AND CONSTRUCTION SIGNING SHALL BE IN STRICT ACCORDANCE WITH THE MANUAL ON UNIFORM TRAFFIC CONTROL DEVICES.
- (8) ALL DETOURS SHALL BE PAVED, STRIPED, SIGNED, AND FLEXIBLE DRUMS ARE TO BE IN PLACE BEFORE IT IS OPENED TO TRAFFIC.
- (9) THE CONTRACTOR SHALL BE RESPONSIBLE FOR STAKING CONSTRUCTION SIGNS. THE COST OF THIS WORK SHALL BE INCLUDED IN ITEM NO. 712-06, SIGNS (CONSTRUCTION), S.F.

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STATE OF TENNESSEE
DEPARTMENT OF TRANSPORTATION

GENERAL NOTES

## **SPECIAL NOTES**

#### **MISCELLANEOUS**

- (1) ALL GUARDRAIL, GUARDRAIL POSTS AND SIGNS WHICH INTERFERE WITH CONSTRUCTION WILL BE REMOVED AND STORED BY STATE FORCES.
- (2) ALL SIGNING AND PAVEMENT MARKINGS ARE TO BE IN ACCORDANCE WITH THE CURRENT EDITION OF THE MANUAL ON UNIFORM TRAFFIC CONTROL DEVICES.

#### **PAVEMENT**

#### RESURFACING

- (2) SURFACE IS TO BE CROWNED AS DIRECTED BY THE TDOT MANAGER.
- (3) THE CONTRACTOR WILL PLACE THE SPOT LEVELING WHERE AND AS DIRECTED BY THE TDOT MANAGER.
- (4) ALL SURPLUS PATCHING, JOINT MATERIAL AND CRACK SEALANT IS TO BE REMOVED BEFORE PLACING THE FIRST LAYER OF ASPHALT.
- (5) STATE FORCES WILL REMOVE ALL RAISED PAVEMENT MARKERS, IF ANY, BEFORE RESURFACING IS BEGUN.
- (6) COLD PLANING IS TO BE DONE IMMEDIATELY PRIOR TO THE COMMENCEMENT OF PAVING OPERATIONS. COLD PLANED SURFACES ARE NOT TO BE LEFT EXPOSED FOR MORE THAN FIVE (5) CALENDAR DAYS BEFORE BEING OVERLAYED BY THE FIRST COURSE OF ASPHALT. IF NECESSARY, COLD PLANING OPERATIONS ARE TO BE SUSPENDED TO ALLOW PAVING OPERATIONS TO CATCH UP. AFTER COLD PLANING AND PRIOR TO ALLOWING USE BY TRAFFIC, THE CONTRACTOR WILL RAMP ASPHALT AROUND EXISTING UTILITIES TO ELIMINATE HAZARD TO VEHICLES. ALL COLD PLANING REQUIRED ON CITY STREETS OR SIDE ROADS WILL BE PAID FOR AT THE UNIT PRICE BID FOR ITEM NO. 415-01.01.
- (7) THE CONTRACTOR SHALL TAKE EXTREME CARE WHEN COLD PLANNING THE EXISTING ASPHALT OFF BRIDGE DECKS AS NOT TO DAMAGE THE EXISTING DECK SEALANT AND/OR EXPANSION JOINT MEMBERS (STEEL PLATES, BARS, AND/OR HEADERS). IF DAMAGE DOES OCCUR THE CONTRACTOR SHALL BE RESPONSIBLE FOR NECESSARY REPAIRS ON ALL DAMAGED MEMBERS TO THE SATISFACTION OF THE TDOT MANAGER AT NO ADDITIONAL COST.

#### **SIGNALIZATION**

- (1) LOOP REPLACEMENT SHALL BE IN ACCORDANCE WITH THE TDOT STANDARD SPECIFICATIONS, SECTION 730.
- (3) SIGNAL DETECTION LOOPS SHALL BE INSTALLED BEFORE THE FINAL SURFACE IS APPLIED.

#### CONSTRUCTION WORK ZONE & TRAFFIC CONTROL

- (1) ANY WORK REQUIRING LANE CLOSURES INCLUDING PAVEMENT MARKING OPERATIONS SHALL BE AT NON-PEAK HOURS (9:00 A.M. TO 3:00 P.M. OR 7:00 P.M. TO 6:00 A.M.) UNLESS OTHERWISE DIRECTED BY THE TDOT MANAGER.
- (4) NO LANE CLOSURES WILL BE ALLOWED ON WEEKENDS (FRIDAY SUNDAY) WHEN THERE IS A SCHEDULED NASCAR RACE IN BRISTOL UNLESS OTHERWISE APPROVED BY THE TDOT MANAGER AND THE REGIONAL TRAFFIC INCIDENT MANAGEMENT COORDINATOR.

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SPECIAL NOTES

# **ENVIRONMENTAL NOTES**

#### **ENVIRONMENTAL GENERAL NOTES**

#### **NATURAL RESOURCES**

- (4) THE OPERATION OF EQUIPMENT IN WATERS OF THE STATE/U.S., INCLUDING WETLANDS AND EPHEMERAL, INTERMITTENT, AND PERENNIAL STREAMS, IS NOT ALLOWED.
- (9) THE CONTRACTOR SHALL TAKE APPROPRIATE STEPS PRIOR TO ANY CONSTRUCTION AND MAINTENANCE ACTIVITIES TO ENSURE THAT ENVIRONMENTAL FEATURES (E.G., STREAMS, WETLANDS, SPRINGS, ETC.) ARE NOT IMPACTED BEYOND PERMITTED LOCATIONS. IF THE CONTRACTOR OR TOOT INSPECTOR IS UNSURE OF THE IDENTITY OF AN ENVIRONMENTAL FEATURE, THE INSPECTOR SHALL CONTACT THE TOOT REGION ENVIRONMENTAL TECH GROUP IMMEDIATELY.

#### **SPECIES**

- (11) SHOULD CLIFF SWALLOW OR BARN SWALLOW NESTS, EGGS, OR BIRDS (YOUNG AND ADULTS) BE PRESENT, THE CONTRACTOR SHALL CONTACT THE REGIONAL ECOLOGY OFFICE TO DETERMINE IF SEASONAL RESTRICTIONS WILL BE NECESSARY. GENERALLY, BIRDS, NESTS, AND EGGS MAY NOT BE DISTURBED BETWEEN APRIL 15 AND JULY 31. FROM AUGUST 1 TO APRIL 14, NESTS CAN BE REMOVED OR DESTROYED SO LONG AS BIRDS OR EGGS ARE NOT PRESENT, AND MEASURES IMPLEMENTED TO PREVENT FUTURE NEST BUILDING AT THE SITE (I.E., CLOSING OFF AREA USING NETTING).
- (12) IF THE REMOVAL OF ANY TREES WITH A DIAMETER AT BREAST HEIGHT (DBH) GREATER THAN 3 INCHES IS DEEMED NECESSARY THE TDOT SUPERVISOR SHALL CONTACT THE TDOT ENVIRONMENTAL DIVISION, ECOLOGY SECTION IMMEDIATELY.

#### PERMITS, PLANS & RECORDS

(15) IF A CHANGE IN PROJECT SCOPE OCCURS DURING CONSTRUCTION, INCLUDING VALUE ENGINEERING, THE TDOT PERMIT SECTION SHALL BE CONTACTED TO DETERMINE WHETHER PERMIT REVISIONS ARE NEEDED. THE ROADWAY DESIGN DIVISION SHALL BE CONTACTED TO DETERMINE IF ANY PLAN REVISIONS ARE NEEDED.

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ENVIRONMENTAL NOTES

# EROSION PREVENTION AND SEDIMENT CONTROL NOTES

# EROSION PREVENTION AND SEDIMENT CONTROL GENERAL NOTES

#### **DISTURBED AREA**

(1) IF DISTURBED ACREAGE IS EQUAL TO ONE ACRE OR MORE, PLEASE CONTACT TDOT ENVIRONMENTAL DIVISION, PERMITS SECTION AS SOON AS POSSIBLE BECAUSE AN NPDES PERMIT WILL BE REQUIRED.

#### SEDIMENT CONTROL

- (6) EPSC MEASURES SHALL BE INSTALLED AND FUNCTIONAL PRIOR TO ANY EARTH MOVING OPERATIONS AND SHALL BE MAINTAINED THROUGHOUT THE CONSTRUCTION PERIOD EXCEPT AS SUCH WORK MAY BE NECESSARY TO INSTALL EPSC MEASURES.
- (8) THE CONTRACTOR SHALL ESTABLISH AND MAINTAIN A PROACTIVE METHOD TO PREVENT THE OFFSITE MIGRATION OR DEPOSIT OF SEDIMENT OFF THE PROJECT LIMITS (E.G. R.O.W., EASEMENTS, ETC.), INTO WATERS OF THE STATE/U.S., OR ONTO ROADWAYS USED BY THE GENERAL PUBLIC. IF SEDIMENT ESCAPES THE CONSTRUCTION SITE, OFFSITE ACCUMULATIONS OF SEDIMENT THAT HAVE NOT REACHED A STREAM MUST BE REMOVED AT A FREQUENCY SUFFICIENT TO MINIMIZE OFFSITE IMPACTS (E.G., FUGITIVE SEDIMENT THAT HAS ESCAPED THE CONSTRUCTION SITE AND HAS COLLECTED IN A STREET MUST BE REMOVED SO THAT IT IS NOT SUBSEQUENTLY WASHED INTO STORM SEWERS AND STREAMS BY THE NEXT RAIN AND/OR SO THAT IT DOES NOT POSE A SAFETY HAZARD TO USERS OF PUBLIC STREETS). ARRANGEMENTS CONCERNING REMOVAL OF SEDIMENT ON ADJOINING PROPERTY MUST BE NEGOTIATED WITH THE ADJOINING PROPERTY OWNER BEFORE REMOVAL OF SEDIMENT.

#### GOOD HOUSEKEEPING MEASURES & WASTE DISPOSAL

- (29) THE CONTRACTOR SHALL ESTABLISH AND MAINTAIN A PROACTIVE METHOD TO PREVENT LITTER AND CONSTRUCTION WASTES FROM ENTERING WATERS OF THE STATE/U.S. THESE MATERIALS SHALL BE REMOVED FROM STORMWATER EXPOSURE PRIOR TO ANTICIPATED STORM EVENTS OR BEFORE BEING CARRIED OFFSITE BY WIND, OR OTHERWISE PREVENTED FROM BECOMING A POLLUTANT SOURCE FOR STORMWATER DISCHARGES. AFTER USE, MATERIALS USED FOR EPSC SHALL BE REMOVED FROM THE SITE.
- (30) THE CONTRACTOR SHALL TAKE APPROPRIATE STEPS TO ENSURE THAT PETROLEUM PRODUCTS OR OTHER CHEMICAL POLLUTANTS ARE PREVENTED FROM ENTERING WATERS OF THE STATE/U.S. ALL EQUIPMENT REFUELING, SERVICING, AND STAGING AREAS SHALL COMPLY WITH ALL LOCAL, STATE, AND FEDERAL LAWS, RULES, REGULATIONS, AND ORDINANCES, INCLUDING THOSE OF THE NATIONAL FIRE PROTECTION ASSOCIATION. APPROPRIATE CONTAINMENT MEASURES FOR THESE AREAS SHALL BE USED.
- (31) CONTRACTORS SHALL PROVIDE DESIGNATED TRUCK WASHOUT AREAS ON THE SITE. THESE AREAS MUST BE SELF CONTAINED, NOT CONNECTED TO ANY STORMWATER OUTLET OF THE SITE, AND PROPERLY SIGNED. WASH DOWN OR WASTE DISCHARGE OF CONCRETE TRUCKS SHALL NOT BE PERMITTED ONSITE UNLESS PROPER SETTLEMENT AREAS HAVE BEEN PROVIDED IN ACCORDANCE WITH BOTH STATE AND FEDERAL REGULATIONS.
- (32) WHEEL WASH WATER SHALL BE COLLECTED AND ALLOWED TO SETTLE OUT SUSPENDED SOLIDS PRIOR TO DISCHARGE. WHEEL WASH WATER SHALL NOT BE DISCHARGED DIRECTLY INTO ANY STORMWATER SYSTEM OR STORMWATER TREATMENT SYSTEM.
- (33) IF PORTABLE SANITARY FACILITIES ARE PROVIDED ON CONSTRUCTION SITES, SANITARY WASTE SHALL BE COLLECTED FROM THE PORTABLE UNITS IN A TIMELY MANNER BY A LICENSED WASTE MANAGEMENT CONTRACTOR OR AS REQUIRED BY ANY REGULATIONS. THE CONTRACTOR SHALL OBTAIN ANY AND ALL NECESSARY PERMITS TO DISPOSE OF SANITARY WASTE.
- (34) ONLY CONSTRUCTION PRODUCTS NEEDED SHALL BE STORED ONSITE BY THE CONTRACTOR. THE CONTRACTOR SHALL STORE ALL MATERIALS UNDER COVER AND IN APPROPRIATE CONTAINERS. PRODUCTS MUST BE STORED IN ORIGINAL CONTAINERS AND LABELED. MATERIAL MIXING SHALL BE CONDUCTED IN ACCORDANCE WITH THE MANUFACTURER'S RECOMMENDATIONS. THE CONTRACTOR'S RESPONSIBLE PARTY SHALL INSPECT MATERIALS STORAGE AREAS REGULARLY TO ENSURE PROPER USE AND DISPOSAL.

- (35) WHEN POSSIBLE, ALL PRODUCTS SHALL BE USED COMPLETELY BEFORE PROPERLY DISPOSING OF THE CONTAINER OFFSITE. THE MANUFACTURER'S DIRECTIONS FOR DISPOSAL OF MATERIALS AND CONTAINERS SHALL BE FOLLOWED.
- (36) ALL PAINT CONTAINERS SHALL BE TIGHTLY SEALED AND STORED WHEN NOT REQUIRED FOR USE. EXCESS PAINT SHALL BE DISPOSED OF ACCORDING TO THE MANUFACTURER'S INSTRUCTIONS AND APPLICABLE STATE AND LOCAL REGULATIONS.
- 37) ALL HAZARDOUS WASTE MATERIALS SHALL BE DISPOSED OF IN A MANNER WHICH IS COMPLIANT WITH LOCAL OR STATE REGULATIONS. SITE PERSONNEL SHALL BE INSTRUCTED IN THESE PRACTICES, AND THE INDIVIDUAL DESIGNATED AS THE CONTRACTOR'S RESPONSIBLE PARTY SHALL BE RESPONSIBLE FOR SEEING THAT THESE PRACTICES ARE FOLLOWED. THE CONTRACTOR SHALL OBTAIN ANY AND ALL NECESSARY PERMITS TO DISPOSE OF HAZARDOUS MATERIAL.
- (38) OPEN BURNING IS PROHIBITED UNLESS IT IS SPECIFICALLY ALLOWED BY LAW. IF ALLOWED, NATURAL VEGETATION, TREES, AND UNTREATED LUMBER SHALL BE THE ONLY MATERIALS THAT CAN BE OPEN BURNED. THE CONTRACTOR SHALL BE RESPONSIBLE FOR OBTAINING ALL APPLICABLE STATE AND LOCAL PERMITS PRIOR TO ANY BURNING.
- (39) DISPOSAL OF ONSITE VEGETATION AND TREES BY CHIPPING THEM INTO MULCH IS PREFERABLE TO OPEN BURNING. THIS MULCH MAY BE USED AS AN ONSITE SOIL STABILIZATION MEASURE WHERE APPROPRIATE.
- (40) WASTE MATERIAL (EARTH, ROCK, ASPHALT, CONCRETE, ETC.) NOT REQUIRED FOR THE CONSTRUCTION OF THE PROJECT WILL BE DISPOSED OF BY THE CONTRACTOR. IMPACTS TO WATERS OF THE STATE/U.S. SHALL BE AVOIDED IF POSSIBLE. IF UNAVOIDABLE, THE CONTRACTOR WILL OBTAIN ANY AND ALL NECESSARY PERMITS INCLUDING, BUT NOT LIMITED TO NPDES, AQUATIC RESOURCES ALTERATION PERMIT(S), CORPS OF ENGINEERS SECTION 404 PERMITS, AND TVA SECTION 26A PERMITS TO DISPOSE OF WASTE MATERIALS.

#### SPILL PREVENTION, MANAGEMENT & NOTIFICATION

- (44) ALL ONSITE VEHICLES SHALL BE MONITORED FOR LEAKS AND RECEIVE REGULAR PREVENTIVE MAINTENANCE TO REDUCE THE CHANCE OF LEAKAGE AND SPILLS.
- (45) FOR ALL HAZARDOUS MATERIALS STORED ONSITE, THE MANUFACTURER'S RECOMMENDED METHODS FOR SPILL CLEAN UP SHALL BE CLEARLY POSTED. SITE PERSONNEL SHALL BE MADE AWARE OF THE PROCEDURES AND THE LOCATIONS OF THE INFORMATION AND CLEANUP SUPPLIES.
- (46) APPROPRIATE CLEANUP MATERIALS AND EQUIPMENT SHALL BE MAINTAINED BY THE CONTRACTOR IN THE MATERIALS STORAGE AREA ONSITE AND UNDER COVER. SPILL RESPONSE EQUIPMENT SHALL BE INSPECTED AND MAINTAINED BY THE CONTRACTOR AS NECESSARY TO REPLACE ANY MATERIALS USED IN SPILL RESPONSE ACTIVITIES.
- (47) ALL SPILLS SHALL BE CLEANED IMMEDIATELY AFTER DISCOVERY AND THE MATERIALS DISPOSED OF PROPERLY. THE SPILL AREA SHALL BE KEPT WELL VENTILATED AND PERSONNEL WILL WEAR APPROPRIATE PROTECTIVE CLOTHING TO PREVENT INJURY FROM CONTACT WITH A HAZARDOUS SUBSTANCE.
- (48) THE CONTRACTOR'S RESPONSIBLE PARTY SHALL BE THE SPILL PREVENTION AND CLEANUP COORDINATOR. THE CONTRACTOR IS RESPONSIBLE FOR ENSURING THAT THE SITE SUPERINTENDENT HAS HAD APPROPRIATE TRAINING FOR HAZARDOUS MATERIALS HANDLING, SPILL MANAGEMENT. AND CLEANUP.
- (49) IF AN OIL SHEEN IS OBSERVED ON SURFACE WATER (E.G. SETTLING PONDS, DETENTION PONDS, SWALES), ACTION SHALL BE TAKEN IMMEDIATELY TO REMOVE THE MATERIAL CAUSING THE SHEEN. THE CONTRACTOR SHALL USE APPROPRIATE MATERIALS TO CONTAIN AND ABSORB THE SPILL. THE SOURCE OF THE OIL SHEEN WILL ALSO BE IDENTIFIED AND REMOVED OR REPAIRED AS NECESSARY TO PREVENT FURTHER RELEASES.
- (50) FERTILIZERS SHALL BE APPLIED ONLY IN THE AMOUNTS SPECIFIED. ONCE APPLIED, FERTILIZERS SHALL BE WORKED INTO THE SOIL TO LIMIT THE EXPOSURE TO STORMWATER.
- (51) IF A SPILL OCCURS THE CONTRACTOR'S RESPONSIBLE PARTY SHALL BE RESPONSIBLE FOR COMPLETING THE SPILL REPORTING FORM AND FOR REPORTING THE SPILL TO THE TDOT PROJECT RESPONSIBLE PARTY. ALL SPILLS MUST BE REPORTED TO THE APPROPRIATE AGENCY, AND MEASURES SHALL BE TAKEN IMMEDIATELY TO PREVENT THE POLLUTION OF WATERS OF THE STATE/U.S., INCLUDING GROUNDWATER, SHOULD A SPILL OCCUR.

- (52) WHERE A RELEASE CONTAINING A HAZARDOUS SUBSTANCE IN AN AMOUNT EQUAL TO OR IN EXCESS OF A REPORTABLE QUANTITY ESTABLISHED UNDER EITHER 40 CFR 117 OR 40 CFR 302 OCCURS DURING A 24 HOUR PERIOD, SEE THE LATEST TENNESSEE GENERAL PERMIT NO. TNR100000 STORMWATER DISCHARGES FROM CONSTRUCTION ACTIVITIES SECTION 5.1 FOR REPORTING REQUIREMENTS
- (53) CONTRACTOR'S BULK FUEL AND PETROLEUM PRODUCTS STORED ONSITE OR ADJACENT TO THE R.O.W. IN ABOVE GROUND STORAGE CONTAINERS WITH A COMBINED CAPACITY OF 1320 GALLONS OR MORE SHALL HAVE SECONDARY CONTAINMENT. THE CONTRACTOR SHALL BE RESPONSIBLE FOR PREPARING A SPILL PREVENTION CONTROL AND COUNTERMEASURE (SPCC) PLAN FOR THE BULK STORAGE AND BE SOLELY RESPONSIBLE FOR OBTAINING ANY NECESSARY LOCAL, STATE, AND FEDERAL PERMITS. THE SPCC PLAN AND/OR PERMITS SHALL BE KEPT ONSITE AND A COPY PROVIDED TO THE TDOT PROJECT RESPONSIBLE PARTY PRIOR TO STORING 1320 GALLONS ON SITE.

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RESURF.	2025	NH/HSIP-34(136)	2E1

STATE OF TENNESSEE
DEPARTMENT OF TRANSPORTATION

EROSION PREVENTION
AND SEDIMENT
CONTROL NOTES


TYPE	YEAR	PROJECT NO.	SHEET NO.	
RESURF.	2025	NH/HSIP-34(136)	2F	

TRAFFIC CONTROL SIGN TABULATION (RESURFACING)								
M.U.T.C.D.			SIZE			TOTAL	ITEM NO.	
SIGN	LEGEND \ DESCRIPTION	IN	INCH	ES	S.F.	NUMBER	712-06	
NO.		L	X	W		REQUIRED	S.F.	
G20-1	ROAD WORK NEXT 6 MILES	48''	Х	24"	8	4	32	
G20-2	END ROAD WORK	48"	X	24"	8	4	32	
W4-2	LANE ENDS	48"	Х	48"	16	8	128	
W8-1	BUMP	48''	Х	48"	16	57	912	
W13-1P	ADVISORY SPEED	30"	Х	30"	6	4	25	
W20-1	ROAD WORK AHEAD	48"	X	48"	16	29	464	
W20-5	LANE CLOSED	48"	Χ	48"	16	16	256	
						TOTAL	1849	

THE CONSTRUCTION SIGNING IS A MINIMUM.
OTHER SIGNS MAY BE REQUIRED AS DIRECTED BY THE TDOT MANAGER.

	PROPOSED GUARDRAIL (RESURFACING)								
						GUARDRAIL			
				GUARDRAIL	TYPE 38	TYPE 21	EARTH PAD	EARTH PAD	
S	IDE	LOG M	IILE	TRANSITION	MASH TL3	MASH TL2	TYPE 38 GR	FOR END	
				27IN TO 31 IN	(26.896')	(21.875')	END TREATMENT	TREATMENT	
LT	RT	LOCAT	ION	705-02.10	705-06.20	705-06.30	704-04.09	705-04.10	
	N I	LOCAT	ION	(EACH)	(EACH)	(EACH)	(EACH)	(EACH)	
	X	6.412	NB	1	1		1		
	X	7.183	NB	1	1		1		
	X	7.267	NB	1	1		1		
	X	7.365	SB	1	1		1		
	X	8.300	NB	1	1		1		
	X	8.389	NB	1	1		1		
	Х	8.801	NB	1	1		1		
ONF	RAMP	8.738	SB	1	1		1		
X	Х	8.916	SB	2		2		2	
		TOTALS		10	8	2	8	2	

CROSSWALK TABULATION										
ROADWAY						LONG.				
//AINLIN	LOCATION	LOG MILE (L.M.)	LEFT	RIGHT		CROSSWALK ITEM NO. 716- 02.09 L.F.	TERMINAL ANCHORS			
S.R. 1	MAPLEHURTS LN./WHITE TOP TD	9.180	Х	Х	T-M-4	120	SEE TDOT PROJECT, PIN 133441.01 - SHEET 28			
S.R. 1	NASCAR BLVD.	9.503		Х	T-M-4	75	SEE TDOT PROJECT, PIN 133441.01 - SHEET 29			
S.R. 1	NASCAR BLVD.	9.515	Х	Х	T-M-4	110	SEE TDOT PROJECT, PIN 133441.01 - SHEET 29			
S.R. 1	OLD THOMAS BRIDGE RD.	9.562	Х		T-M-4	45	SEE TDOT PROJECT, PIN 133441.01 - SHEET 29			
S.R. 1	RACEDAY CENTER DR.	9.640	Х		T-M-4	90	SEE TDOT PROJECT, PIN 133441.01 - SHEET 30			
S.R. 1	SPEEDWAY BLVD.	9.812	X	Х	T-M-4	100	SEE TDOT PROJECT, PIN 133441.01 - SHEET 30			
S.R. 1	SPEEDWAY BLVD.	9.825		Х	T-M-4	105	SEE TDOT PROJECT, PIN 133441.01 - SHEET 30			
S.R. 1	SPEEDWAY BLVD.	9.840	X	Х	T-M-4	105	SEE TDOT PROJECT, PIN 133441.01 - SHEET 30			
S.R. 1	KINGSTON RD.	10.047		Х	T-M-4	102	SEE TDOT PROJECT, PIN 133441.01 - SHEET 31			
S.R. 1	EXIDE DR.	10.162	X		T-M-4	40	SEE TDOT PROJECT, PIN 133441.01 - SHEET 32			
S.R. 1	EXIDE DR.	10.169	X		T-M-4	38	SEE TDOT PROJECT, PIN 133441.01 - SHEET 32/3			
S.R. 1	EXIDE DR.	10.226	X		T-M-4	70	SEE TDOT PROJECT, PIN 133441.01 - SHEET 33			
				•	TOTAL	1000				

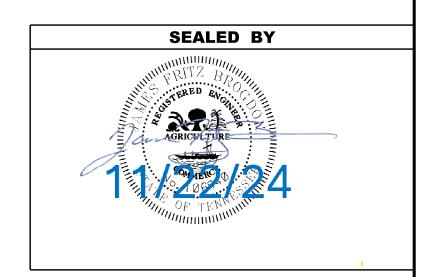

STATE OF TENNESSEE
DEPARTMENT OF TRANSPORTATION

TABULATED QUANTITIES

#### UTILITY

- (2) UNLESS OTHERWISE NOTED, ALL UTILITY ADJUSTMENTS WILL BE PERFORMED BY THE UTILITY OR ITS REPRESENTATIVE. THE CONTRACTOR AND UTILITY OWNERS WILL BE REQUIRED TO COOPERATE WITH EACH OTHER IN ORDER TO EXPEDITE THE WORK REQUIRED BY THIS CONTRACT. ON CONTRACTS WHERE CONSTRUCTION STAKES, LINES, AND GRADES ARE CONTRACT ITEMS, THE CONTRACTOR WILL BE REQUIRED TO PROVIDE RIGHT-OF-WAY OR SLOPE STAKES, DITCH OR STREAM BED GRADES, OR OTHER ESSENTIAL SURVEY STAKING TO PREVENT CONFLICTS WITH THE HIGHWAY CONSTRUCTION. FREQUENTLY, THIS WILL BE REQUIRED AS THE FIRST ITEM OF WORK AND AT ANY LOCATION ON THE PROJECT DIRECTED BY THE ENGINEER.
- (3) THE CONTRACTOR WILL PROVIDE ALL NECESSARY PROTECTIVE MEASURES TO SAFEGUARD EXISTING UTILITIES FROM DAMAGE DURING CONSTRUCTION OF THIS PROJECT. IN THE EVENT THAT SPECIAL EQUIPMENT IS REQUIRED TO WORK OVER AND AROUND THE UTILITIES, THE CONTRACTOR WILL BE REQUIRED TO FURNISH SUCH EQUIPMENT. THE COST OF PROTECTING UTILITIES FROM DAMAGE AND FURNISHING SPECIAL EQUIPMENT WILL BE INCLUDED IN THE PRICE BID FOR OTHER ITEMS OF CONSTRUCTION.
- (4) PRIOR TO SUBMITTING HIS BID, THE CONTRACTOR WILL BE SOLELY RESPONSIBLE FOR CONTACTING OWNERS OF ALL AFFECTED UTILITIES IN ORDER TO DETERMINE THE EXTENT TO WHICH UTILITY RELOCATIONS AND/OR ADJUSTMENTS WILL HAVE UPON THE SCHEDULE OF WORK FOR THE PROJECT. WHILE SOME WORK MAY BE REQUIRED 'AROUND' UTILITY FACILITIES THAT WILL REMAIN IN PLACE, OTHER UTILITY FACILITIES MAY NEED TO BE ADJUSTED CONCURRENTLY WITH THE CONTRACTOR'S OPERATIONS. ADVANCE CLEAR CUTTING MAY BE REQUIRED BY THE ENGINEER AT ANY LOCATION WHERE CLEARING IS CALLED FOR IN THE SPECIFICATIONS AND CLEAR CUTTING IS NECESSARY FOR A UTILITY RELOCATION. ANY ADDITIONAL COST WILL BE INCLUDED IN THE UNIT PRICE BID FOR THE CLEARING ITEM SPECIFIED IN THE PLANS.
- THE CONTRACTOR SHALL NOTIFY EACH INDIVIDUAL UTILITY OWNER OF HIS PLAN OF OPERATION IN THE AREA OF THE UTILITIES. PRIOR TO COMMENCING WORK, THE CONTRACTOR SHALL CONTACT THE UTILITY OWNERS AND REQUEST THEM TO PROPERLY LOCATE THEIR RESPECTIVE UTILITY ON THE GROUND. THIS NOTIFICATION SHALL BE GIVEN AT LEAST THREE (3) BUSINESS DAYS PRIOR TO COMMENCEMENT OF OPERATIONS AROUND THE UTILITY IN ACCORDANCE WITH TCA 65-31-106. NOTIFICATION BY CALLING THE TENNESSEE ONE CALL SYSTEM, INC AT 1-800-351-1111 WILL BE REQUIRED.

# UTILITY OWNERS SULLIVAN COUNTY

#### CABLE:

BVU AUTHORITY

15022 LEE HWY

BRISTOL, VA 24202

CONTACT: DAVID COPELAND

OFFICE PHONE: (276) 669-4112

CELL PHONE: (276) 696-1652

Email: copeland@bvub.com

#### ELECTRIC:

AEP – KINGSPORT POWER COMPANY
420 RIVERPORT ROAD

KINGSPORT, TN 37660

CONTACT: TOM HENSLEY

OFFICE PHONE: (423) 578-2249

CELL PHONE: \_\_\_\_

Email: tdhensley@aep.com

#### GAS: ATMOS

2833 WEST MARKET STREET JOHNSON CITY, TN 37604 CONTACT: ISAIAH GREER OFFICE PHONE:

CELL PHONE: (423) 202-1455
Email: isaiah.greer@atmosenergy.com

#### TELEPHONE:

AT&T LONGHAUL

Email: Kl2863@att.com

360 GEES MILL BUSINESS PARKWAY
CONYERS, GA 30013
CONTACT: TRINA IVEY
OFFICE PHONE: (678) 641-5522
CELL PHONE:

#### SEWER:

**BVU AUTHORITY** 

15022 LEE HWY BRISTOL, VA 24202

CONTACT: DAVID COPELAND
OFFICE PHONE: (276) 669-4112
CELL PHONE: (276) 696-1652
Email: copeland@bvub.com

#### **ELECTRIC:**

BRIGHTRIDGE

2600 BOONES CREEK ROAD
JOHNSON CITY, TN 37605
CONTACT: KEN EDGAR
OFFICE PHONE: (423) 952-5030
CELL PHONE: (423) 833-2841
Email: kedgar@brightridge.com

#### WATER:

CITY OF JOHNSON CITY WATER & SEWER SERVICES DEPT

601 E MAIN STREET

JOHNSON CITY, TN 37601

CONTACT: JEFF HARMON

OFFICE PHONE: (423) 975-2624


CELL PHONE: (423) 262-9245


Email: jeffharmon@johnsoncitytn.org

#### TELEPHONE:

BRIGHTSPEED

101 NORTH ROAN STREET
JOHNSON CITY, TN 37601
CONTACT: ANDREW ICE
OFFICE PHONE: (423) 461-7724
CELL PHONE: (423) 470-5636
Email: andrew.f.ice@brightspeed.com

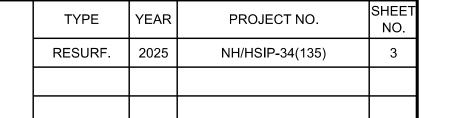

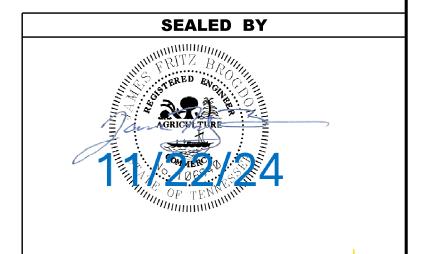

STATE OF TENNESSEE
DEPARTMENT OF TRANSPORTATION

UTILITY NOTES

AND

UTILITY OWNERS

### PAVEMENT EDGE DROP-OFF TRAFFIC CONTROL NOTES

- A. DIFFERENCES IN ELEVATION BETWEEN ADJACENT TRAFFIC LANES OR TRAFFIC LANE AND SHOULDER WHERE THE TRAFFIC LANE IS BEING USED BY TRAFFIC, CAUSED BY BASE, PAVING OR RESURFACING:
  - DIFFERENCES IN ELEVATION BETWEEN ADJACENT ROADWAY ELEMENTS GREATER THAN 0.75 INCH AND NOT EXCEEDING 1.75 INCHES:
    - WARNING SIGNS, UNEVEN LANES (W8-11) AND/OR SHOULDER DROP-OFF WITH PLAQUE (W8-17 AND W8-17P), SHALL BE PLACED IN ADVANCE OF AND THROUGHOUT THE EXPOSED AREA MAXIMUM SPACING BETWEEN SIGNS SHALL BE 2.000 FEET WITH A MINIMUM OF 2 SIGNS PER EXPOSED AREA. WHERE UNEVEN PAVEMENT IS ENCOUNTERED, SIGNS SHALL BE PLACED ON EACH SIDE OF THE ROADWAY.
    - DIFFERENCES IN ELEVATION BETWEEN ADJACENT TRAFFIC LANES BEING UTILIZED BY TRAFFIC CAUSED BY ADDED PAVEMENT SHALL BE ELIMINATED WITHIN THREE WORKDAYS.
    - DIFFERENCES IN ELEVATION BETWEEN ADJACENT TRAFFIC LANES BEING UTILIZED BY TRAFFIC CAUSED BY COLD PLANING SHALL BE ELIMINATED WITHIN THREE WORKDAYS.
    - WHEN THE DIFFERENCE IN ELEVATION IS BETWEEN THE TRAFFIC LANE BEING UTILIZED BY TRAFFIC AND SHOULDER THE DIFFERENCE IN ELEVATION SHALL BE ELIMINATED WITHIN SEVEN WORKDAYS AFTER THE CONDITION IS CREATED.
  - 2. DIFFERENCES IN ELEVATION BETWEEN ADJACENT ROADWAY ELEMENTS GREATER THAN 1.75 INCHES AND NOT EXCEEDING 6 INCHES, TRAFFIC IS NOT TO BE ALLOWED TO TRAVERSE THIS DIFFERENCE IN ELEVATION.
    - SEPARATION SHALL BE ACCOMPLISHED BY DRUMS, BARRICADES OR OTHER APPROVED DEVICES IN ACCORDANCE WITH THE FOLLOWING:
      - (1) WHERE POSTED SPEEDS ARE 50 MPH OR GREATER, SPACING OF THE PROTECTIVE DEVICES SHALL NOT EXCEED 100 FEET.
      - WHERE POSTED SPEEDS ARE LESS THAN 50 MPH, THE MAXIMUM SPACING OF THE PROTECTIVE DEVICES IN FEET SHALL NOT EXCEED TWICE THE POSTED SPEED IN MILES PER HOUR OR 50 FEET, WHICHEVER SPACING IS GREATER
    - b. IF THE DIFFERENCE IN ELEVATION IS ELIMINATED OR DECREASED TO 2 INCHES OR LESS BY THE END OF EACH WORKDAY, CONES MAY BE USED DURING DAYLIGHT HOURS IN LIEU OF DRUMS, BARRICADES OR OTHER APPROVED PROTECTIVE DEVICES MENTIONED IN PARAGRAPH a. PROVIDED WARNING SIGNS ARE ERECTED. WARNING SIGNS (UNEVEN LANES AND/OR SHOULDER DROP-OFF) SHALL BE PLACED IN ADVANCE OF AND THROUGHOUT THE EXPOSED AREA. MAXIMUM SPACING BETWEEN SIGNS SHALL BE 2,000 FEET WITH A MINIMUM OF 2 SIGNS PER EXPOSED AREA. WHERE UNEVEN PAVEMENT IS ENCOUNTERED. SIGNS SHALL BE PLACED ON EACH SIDE OF THE ROADWAY.
    - WHEN THE DIFFERENCE IN ELEVATION IS BETWEEN THE THROUGH TRAFFIC LANE AND THE SHOULDER AND THE ELEVATION DIFFERENCE IS LESS THAN 3 INCHES, THE CONTRACTOR MAY USE WARNING SIGNS AND/OR PROTECTIVE DEVICES AS APPLICABLE AND APPROVED BY THE REGIONAL TRAFFIC ENGINEER. SEE PARAGRAPH a REGARDING USE OF DRUMS, BARRICADES OR OTHER APPROVED PROTECTIVE DEVICES. WARNING SIGNS (UNEVEN LANES AND/OR SHOULDER DROP-OFF) WILL BE PLACED IN ADVANCE OF AND THROUGHOUT THE EXPOSED AREA. MAXIMUM SPACING BETWEEN SIGNS SHALL BE 2,000 FEET WITH A MINIMUM OF 2 SIGNS PER EXPOSED AREA. WHERE UNEVEN PAVEMENT IS ENCOUNTERED. SIGNS SHALL BE PLACED ON EACH SIDE OF THE ROADWAY.

IN THESE SITUATIONS, THE CONTRACTOR SHALL LIMIT HIS OPERATIONS TO ONE WORK ZONE NOT EXCEEDING 2 MILES IN LENGTH UNLESS OTHERWISE NOTED ON THE PLANS OR APPROVED BY THE ENGINEER. ONCE THE CONTRACTOR BEGINS WORK IN A WORK ZONE, A CONTINUOUS OPERATION SHALL BE MAINTAINED UNTIL THE DIFFERENCE IN ELEVATION IS ELIMINATED. SIMULTANEOUS WORK ON SEPARATE ROADWAYS OF DIVIDED HIGHWAYS WILL BE CONSIDERED INDEPENDENTLY IN REGARD TO RESTRICTION OF WORK ZONE ACTIVITY.

- DIFFERENCES IN ELEVATION BETWEEN ADJACENT ROADWAY ELEMENTS GREATER THAN 6 INCHES BUT NOT EXCEEDING 18 INCHES. THE CONTRACTOR, WITH THE ENGINEER'S APPROVAL. MAY UTILIZE ONE OF THE FOLLOWING:
  - THE CONTRACTOR SHALL ACCOMPLISH SEPARATION BY DRUMS. BARRICADES OR OTHER APPROVED DEVICES IN ACCORDANCE WITH THE FOLLOWING:
    - (1) WHERE POSTED SPEEDS ARE 50 MPH OR GREATER, SPACING OF THE PROTECTIVE DEVICES SHALL NOT EXCEED
    - WHERE POSTED SPEEDS ARE LESS THAN 50 MPH, THE MAXIMUM SPACING OF THE PROTECTIVE DEVICES IN FEET SHALL NOT EXCEED TWICE THE POSTED SPEED IN MILES PER HOUR OR 50 FEET. WHICHEVER SPACING IS GREATER.

IN ORDER TO USE THIS METHOD. THE CONTRACTOR MUST REDUCE THE DIFFERENCE IN ELEVATION TO 6 INCHES OR LESS BY THE END OF THE WORKDAY THAT THE CONDITION IS CREATED.

- THE CONTRACTOR SHALL PROVIDE DRUMS, BARRICADES OR OTHER APPROVED SEPARATION DEVICES AS SPECIFIED IN PARAGRAPH a, AND CONSTRUCT A STONE WEDGE WITH A 4:1 SLOPE, OR FLATTER, TO ELIMINATE THE VERTICAL OFFSET IF THE LOWER ELEVATION IS AT OR BELOW SUBGRADE AT THE END OF EACH DAY.
- THE CONTRACTOR SHALL PROVIDE DRUMS, BARRICADES OR OTHER APPROVED SEPARATION DEVICES AS SPECIFIED IN PARAGRAPH a AND IF THE LOWER ELEVATION IS BASE STONE OR ASPHALT PAVEMENT, PLACEMENT OF SUBSEQUENT LAYERS OF PAVEMENT MUST BEGIN THE NEXT WORK DAY AND PROGRESS CONTINUOUSLY UNTIL THE DIFFERENCE IN ELEVATION IS ELIMINATED OR REDUCED TO SIX INCHES OR LESS.
- THE CONTRACTOR SHALL PROVIDE SEPARATION BY PORTABLE BARRIER RAIL.

FOR PRECEDING CONDITIONS a, b, AND c, THE CONTRACTOR SHALL USE THE SHOULDER DROP-OFF WARNING SIGN WITH PLAQUE (W8-17 AND W8-17P). IT SHALL BE PLACED IN ADVANCE OF AND THROUGHOUT THE EXPOSED AREA. MAXIMUM SPACING BETWEEN THE SIGNS SHALL BE 2,000 FEET WITH A MINIMUM OF 2 SIGNS PER EXPOSED AREA. IN THESE SITUATIONS. THE CONTRACTOR SHALL LIMIT HIS OPERATIONS TO ONE WORK ZONE NOT EXCEEDING 1 MILE IN LENGTH UNLESS OTHERWISE NOTED ON THE PLANS OR APPROVED BY THE ENGINEER ONCE THE CONTRACTOR BEGINS WORK IN A WORK ZONE. A CONTINUOUS OPERATION SHALL BE MAINTAINED UNTIL THE DIFFERENCE IS ELIMINATED. SIMULTANEOUS WORK ON SEPARATE ROADWAYS OF DIVIDED HIGHWAYS WILL BE CONSIDERED INDEPENDENTLY IN REGARD TO RESTRICTION OF WORK ZONE ACTIVITY.

FOR DIFFERENCES IN ELEVATION BETWEEN ADJACENT ROADWAY **ELEMENTS GREATER THAN 18 INCHES.** 

SEPARATION WILL BE PROVIDED BY USE OF PORTABLE BARRIER RAIL

IN THIS SITUATION THE CONTRACTOR SHALL LIMIT HIS OPERATIONS TO ONE WORK ZONE NOT EXCEEDING 1 MILE IN LENGTH UNLESS OTHERWISE NOTED ON THE PLANS OR APPROVED BY THE ENGINEER. ONCE THE CONTRACTOR BEGINS WORK IN A WORK ZONE, A CONTINUOUS OPERATION SHALL BE MAINTAINED UNTIL THE DIFFERENCE IN ELEVATION IS ELIMINATED. SIMULTANEOUS WORK ON SEPARATE ROADWAYS OF DIVIDED HIGHWAYS WILL BE CONSIDERED INDEPENDENTLY IN REGARD TO RESTRICTION OF WORK ZONE ACTIVITY.

		4
IF THE DIFFERENCE IN ELEVATION IS WITHIN 30 FEET OF THE		
NEAREST TRAFFIC LANE BEING USED BY TRAFFIC CAUSED BY		
GRADING, EXCAVATION FOR UTILITIES, DRAINAGE STRUCTURES,		

1. IF THE DIFFERENCE IN ELEVATION IS WITHIN 8 FEET OF THE NEAREST TRAFFIC LANE WITH DIFFERENCE IN ELEVATION GREATER THAN 3/4 INCH AND NOT EXCEEDING 2 INCHES.

В.

UNDERCUTTING. ETC.:

- WARNING SIGNS (UNEVEN LANES AND/OR SHOULDER DROP-OFF) SHALL BE PLACED IN ADVANCE OF AND THROUGHOUT THE EXPOSED AREA. MAXIMUM SPACING BETWEEN SIGNS SHALL BE 2,000 FEET WITH A MINIMUM OF 2 SIGNS PER EXPOSED AREA. WHERE UNEVEN PAVEMENT IS ENCOUNTERED. SIGNS SHALL BE PLACED ON EACH SIDE OF THE ROADWAY.
- 2. IF THE DIFFERENCE IN ELEVATION IS WITHIN 8 FEET OF THE NEAREST TRAFFIC LANE WITH DIFFERENCE IN ELEVATION GREATER THAN 2 **INCHES AND NOT EXCEEDING 6 INCHES:** 
  - SEPARATION SHALL BE ACCOMPLISHED BY DRUMS, BARRICADES OR OTHER APPROVED DEVICES IN ACCORDANCE WITH THE FOLLOWING:
    - WHERE POSTED SPEEDS ARE 50 MPH OR GREATER, SPACING OF THE PROTECTIVE DEVICES SHALL NOT EXCEED 100 FEET.
    - WHERE POSTED SPEEDS ARE LESS THAN 50 MPH THE MAXIMUM SPACING OF THE PROTECTIVE DEVICES IN FEET SHALL NOT EXCEED TWICE THE POSTED SPEED IN MILES PER HOUR OR 50 FEET. WHICHEVER SPACING IS GREATER.
- IF THE DIFFERENCE IN ELEVATION IS WITHIN 8 FEET OF THE NEAREST TRAFFIC LANE WITH DIFFERENCE IN ELEVATION GREATER THAN 6 **INCHES**:
  - SEPARATION SHALL BE ACCOMPLISHED BY DRUMS, BARRICADES OR OTHER APPROVED DEVICES IN ACCORDANCE WITH THE FOLLOWING:
    - (1) WHERE POSTED SPEEDS ARE 50 MPH OR GREATER, SPACING OF THE PROTECTIVE DEVICES SHALL NOT EXCEED 100 FEET.
    - WHERE POSTED SPEEDS ARE LESS THAN 50 MPH THE MAXIMUM SPACING OF THE PROTECTIVE DEVICES IN FEET SHALL NOT EXCEED TWICE THE POSTED SPEED IN MILES PER HOUR OR 50 FEET. WHICHEVER SPACING IS GREATER.
  - ELIMINATE VERTICAL OFFSET BY CONSTRUCTING A STONE WEDGE OR GRADING TO A 4:1 SLOPE, OR FLATTER, OR USE PORTABLE BARRIER RAIL


THE CONTRACTOR SHALL SCHEDULE THE WORK SO AS TO MINIMIZE THE TIME TRAFFIC IS EXPOSED TO AN ELEVATION DIFFERENCE. ONCE THE CONTRACTOR BEGINS AN ACTIVITY THAT CREATES AN ELEVATION DIFFERENCE WITHIN 8 FEET OF A TRAFFIC LANE. THE ACTIVITY SHALL BE PURSUED AS A CONTINUOUS OPERATION UNTIL THE ELEVATION DIFFERENCE IS ELIMINATED.

C. IF THE DIFFERENCE IN ELEVATION IS FARTHER THAN 8 FEET FROM THE NEAREST TRAFFIC LANE BUT NOT MORE THAN 30 FEET FROM THE NEAREST TRAFFIC LANE:

SEPARATION SHALL BE ACCOMPLISHED BY DRUMS. BARRICADES OR OTHER APPROVED DEVICES IN ACCORDANCE WITH THE FOLLOWING:

- 1. WHERE POSTED SPEEDS ARE 50 MPH OR GREATER, SPACING OF THE PROTECTIVE DEVICES SHALL NOT EXCEED 100 FEET.
- 2. WHERE POSTED SPEEDS ARE LESS THAN 50 MPH, THE MAXIMUM SPACING OF THE PROTECTIVE DEVICES IN FEET SHALL NOT EXCEED TWICE THE POSTED SPEED IN MILES PER HOUR OR 50 FEET. WHICHEVER SPACING IS GREATER.

THE CONTRACTOR SHALL SCHEDULE THE WORK SO AS TO MINIMIZE THE TIME TRAFFIC IS EXPOSED TO AN ELEVATION DIFFERENCE. ONCE THE CONTRACTOR BEGINS AN ACTIVITY THAT CREATES AN ELEVATION DIFFERENCE, THE ACTIVITY SHALL BE PURSUED AS A CONTINUOUS OPERATION UNTIL THE ELEVATION DIFFERENCE IS ELIMINATED.

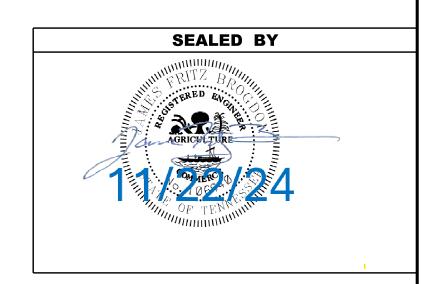

SHEE NO.

PROJECT NO.

NH/HSIP-34(135)

YEAR

2025

TYPE

RESURF.

**STATE OF TENNESSEE DEPARTMENT OF TRANSPORTATION** 

PAVEMENT EDGE **DROP-OFF NOTES** FOR TRAFFIC CONTROL

TYPEYEARPROJECTFIGURE NO.SAFETY2023R1SVAR-F3-02827

## R1SVAR-F3-028 END PROJECT NO. HSIP-REG1 (213) RESURFACE & SAFETY SR-34, L.M. 11.60 (A378 HATCHALL WAY RT.)

In the second se

SULLIVAN COUNTY

R1SVAR-F3-028 BEGIN PROJECT NO. HSIP-REG1 (213) PRELIMINARY SR-34, L.M. 6.11 (END OF HOLSTON RIVER BRIDGE.)

TDOT REGION 1 DISTRICT 17 CURB RAMP IMPROVEMENTS

STATE OF TENNESSEE
DEPARTMENT OF TRANSPORTATION
S.T.I.D.

LOCATION MAP

R1SVAR-F3-028

END PROJECT NO. HSIP-REG1 (213)

(BEGIN AIRPORT ACCESS ROAD.)

RESURFACE & SAFETY

CENTER OF OVERHEAD.)

R1SVAR-F3-028

SR-357, L.M. 0.00 (I-81 RT. & LT. /


BEGIN PROJECT NO. HSIP-REG1 (213)

**RESURFACE & SAFETY** 

SR-357, L.M. 2.42

SAFETY 2023 R1SVAR-F3-028

SR-34 AT MAPLEHURST LN.

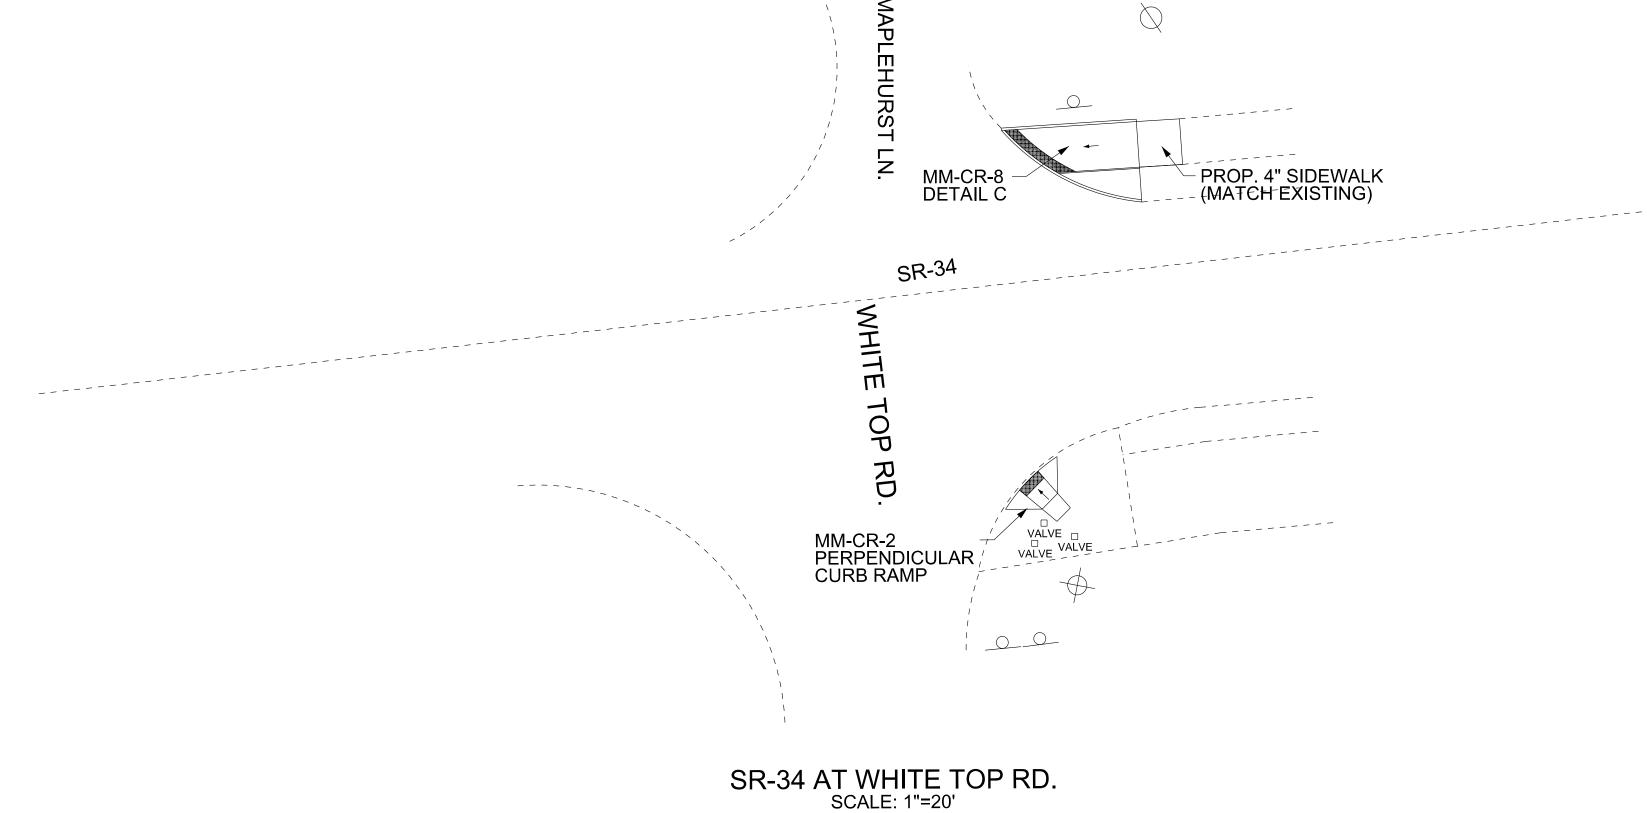

NOTE:

CONTRACTOR SHALL REMOVE ALL CONFLICTING PAVEMENT MARKINGS INCLUDING EXISTING CROSSWALKS AND STOP LINES.

PROPOSED CROSS WALKS, STOP LINES AND PAVEMENT SHALL BE INSTALLED USING PLASTIC/THERMOPLASTIC PAVEMENT MARKINGS.

ALL UTILITY LOCATIONS SHOWN ON THESE PLANS ARE APPROXIMATE. THE CONTRACTOR SHALL FIELD LOCATE ALL UTILITIES PRIOR TO BEGINNING CONSTRUCTION.
CONTRACTOR SHALL TAKE CARE TO AVOID ALL EXISTING UTILITIES.

**EXISTING SIGN** 

EXISTING FIRE HYDRANT EXISTING WATER/GAS VALVE 🛛 EXISTING UTILITY BOX EXISTING MAIL BOX

**EXISTING MANHOLE** 

**EXISTING STORM INLET EXISTING UTILITY POLE** EXISTING LIGHT POLE

LEGEND --- ( EXISTING GUY WIRE

⊕-⊕-⊕ EXISTING GUARDRAIL

**EXISTING SIGNAL POLE** 

○-IPB--EXISTING PED PUSHBUTTON

\* \* \* EXISTING FENCE PROP. STOP LINE EXISTING SIGNAL CONTROL PROP. CROSS WALK DETECTABLE WARNING SURFACE

PROP. LONGITUDINAL CROSS WALK

# TDOT REGION 1 DISTRICT 17 CURB RAMP IMPROVEMENTS

SR-34 LOG MILE 6.11 TO LOG MILE 11.60 SULLIVAN COUNTY


DEPARTMENT OF TRANSPORTATION S.T.I.D.

STATE OF TENNESSEE

LAYOUT L.M. 9.18

SCALE: 1"= 50'

**PROJECT** SAFETY 2023 R1SVAR-F3-028

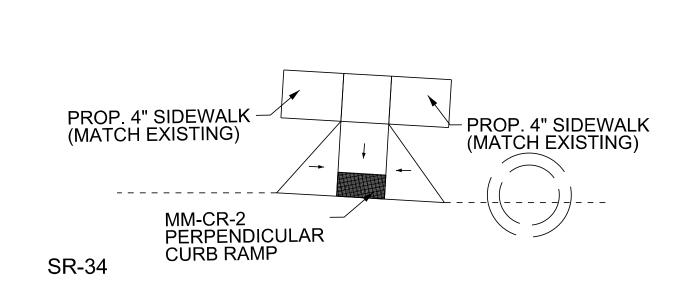

PROP. 4" SIDEWALK (MATCH EXISTING) MM-CR-5 LOWERED CORNER CURB RAMP WITH BI-DIRECTIONAL SIDEWALK PROP. 4" SIDEWALK (MATCH EXISTING) -----

PROP. 4" SIDEWALK (MATCH EXISTING) LOWERED CORNER CURB RAMP WITH BI-DIRECTIONAL SIDEWALK .\_\_\_\_\_\_ PROP. 4" SIDEWALK (MATCH EXISTING)


SR-34

\_\_\_\_\_

SR-34 AT OLD THOMAS BRIDGE RD.

SCALE: 1"=20'

RD

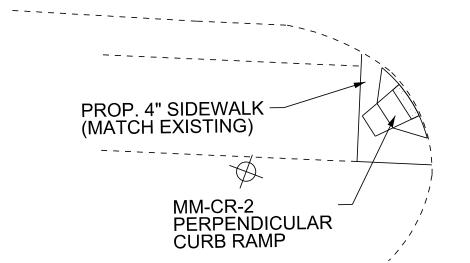

SR-34 AT NASCAR BLVD. SCALE: 1"=20'

AR BLVD

NOTE:

CONTRACTOR SHALL REMOVE ALL CONFLICTING PAVEMENT MARKINGS INCLUDING EXISTING CROSSWALKS AND STOP LINES.

PROPOSED CROSS WALKS, STOP LINES AND PAVEMENT SHALL BE INSTALLED USING PLASTIC/THERMOPLASTIC PAVEMENT MARKINGS.

ALL UTILITY LOCATIONS SHOWN ON THESE PLANS ARE APPROXIMATE. THE CONTRACTOR SHALL FIELD LOCATE ALL UTILITIES PRIOR TO BEGINNING CONSTRUCTION. CONTRACTOR SHALL TAKE CARE TO AVOID ALL EXISTING UTILITIES.

#### LEGEND

- **EXISTING SIGN**
- EXISTING FIRE HYDRANT EXISTING WATER/GAS VALVE 🛛
- EXISTING MAIL BOX **EXISTING MANHOLE**
- **EXISTING STORM INLET**
- $\ominus$ EXISTING UTILITY POLE EXISTING LIGHT POLE
- EXISTING SIGNAL CONTROL EXISTING UTILITY BOX
- DETECTABLE WARNING SURFACE v-v-v EXISTING GUARDRAIL
- **EXISTING SIGNAL POLE →** EXISTING PED PUSHBUTTON
- \* \* \* EXISTING FENCE PROP. STOP LINE PROP. CROSS WALK

PROP. LONGITUDINAL CROSS WALK

# TDOT REGION 1 DISTRICT 17 CURB RAMP IMPROVEMENTS


SR-34 LOG MILE 6.11 TO LOG MILE 11.60 **SULLIVAN COUNTY** 

STATE OF TENNESSEE **DEPARTMENT OF TRANSPORTATION** S.T.I.D.


> LAYOUT L.M. 9.49 TO L.M. 9.57

SCALE: 1"= 50'

**PROJECT** SAFETY 2023 R1SVAR-F3-028

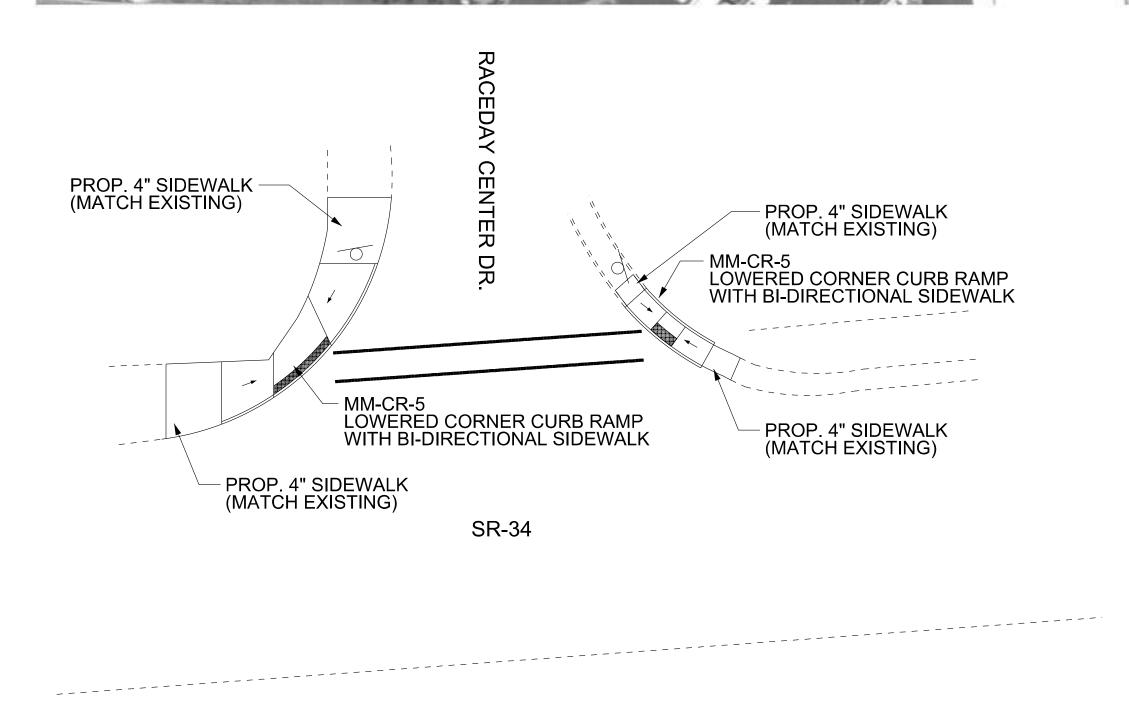

PROP. 4" SIDEWALK - (MATCH EXISTING) PROP. 4" SIDEWALK (MATCH EXISTING) PROP. 4" SIDEWALK MM-CR-2 PERPENDICULAR CURB RAMP (MATCH EXISTING) MM-CR-2 PERPENDICULAR CURB RAMP (MATCH EXISTING)

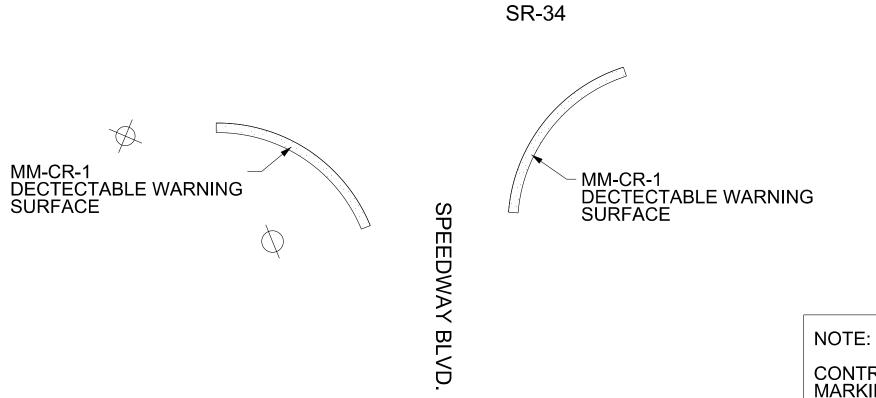

SR-34 AT SPEEDWAY BLVD. SCALE: 1"=20'

CONTRACTOR SHALL REMOVE ALL CONFLICTING PAVEMENT MARKINGS INCLUDING EXISTING CROSSWALKS AND STOP LINES.

PROPOSED CROSS WALKS, STOP LINES AND PAVEMENT SHALL BE INSTALLED USING PLASTIC/THERMOPLASTIC PAVEMENT MARKINGS.

ALL UTILITY LOCATIONS SHOWN ON THESE PLANS ARE APPROXIMATE. THE CONTRACTOR SHALL FIELD LOCATE ALL UTILITIES PRIOR TO BEGINNING CONSTRUCTION. CONTRACTOR SHALL TAKE CARE TO AVOID ALL EXISTING UTILITIES.

**EXISTING SIGN** 

**EXISTING FIRE HYDRANT** EXISTING WATER/GAS VALVE 🛛

**EXISTING MAIL BOX EXISTING MANHOLE** 

**EXISTING STORM INLET EXISTING UTILITY POLE EXISTING LIGHT POLE** 

LEGEND

\* \* \* EXISTING FENCE EXISTING SIGNAL CONTROL PROP. STOP LINE PROP. CROSS WALK **EXISTING UTILITY BOX** DETECTABLE WARNING PROP. LONGITUDINAL CROSS WALK

OF REAL PROPERTY AND PERSONS NAMED IN

SR-34 LOG MILE 6.11 TO LOG MILE 11.60 **SULLIVAN COUNTY** 

TDOT REGION 1 DISTRICT 17 CURB RAMP IMPROVEMENTS

STATE OF TENNESSEE **DEPARTMENT OF TRANSPORTATION** S.T.I.D.

> LAYOUT L.M. 9.64 TO L.M. 9.84

SCALE: 1"= 50'

--- ( EXISTING GUY WIRE


SR-34 AT RACEDAY CENTER DR.


SCALE: 1"=20'

SURFACE **▽─▽─▽ EXISTING GUARDRAIL** 

EXISTING SIGNAL POLE

© IPB EXISTING PED PUSHBUTTON

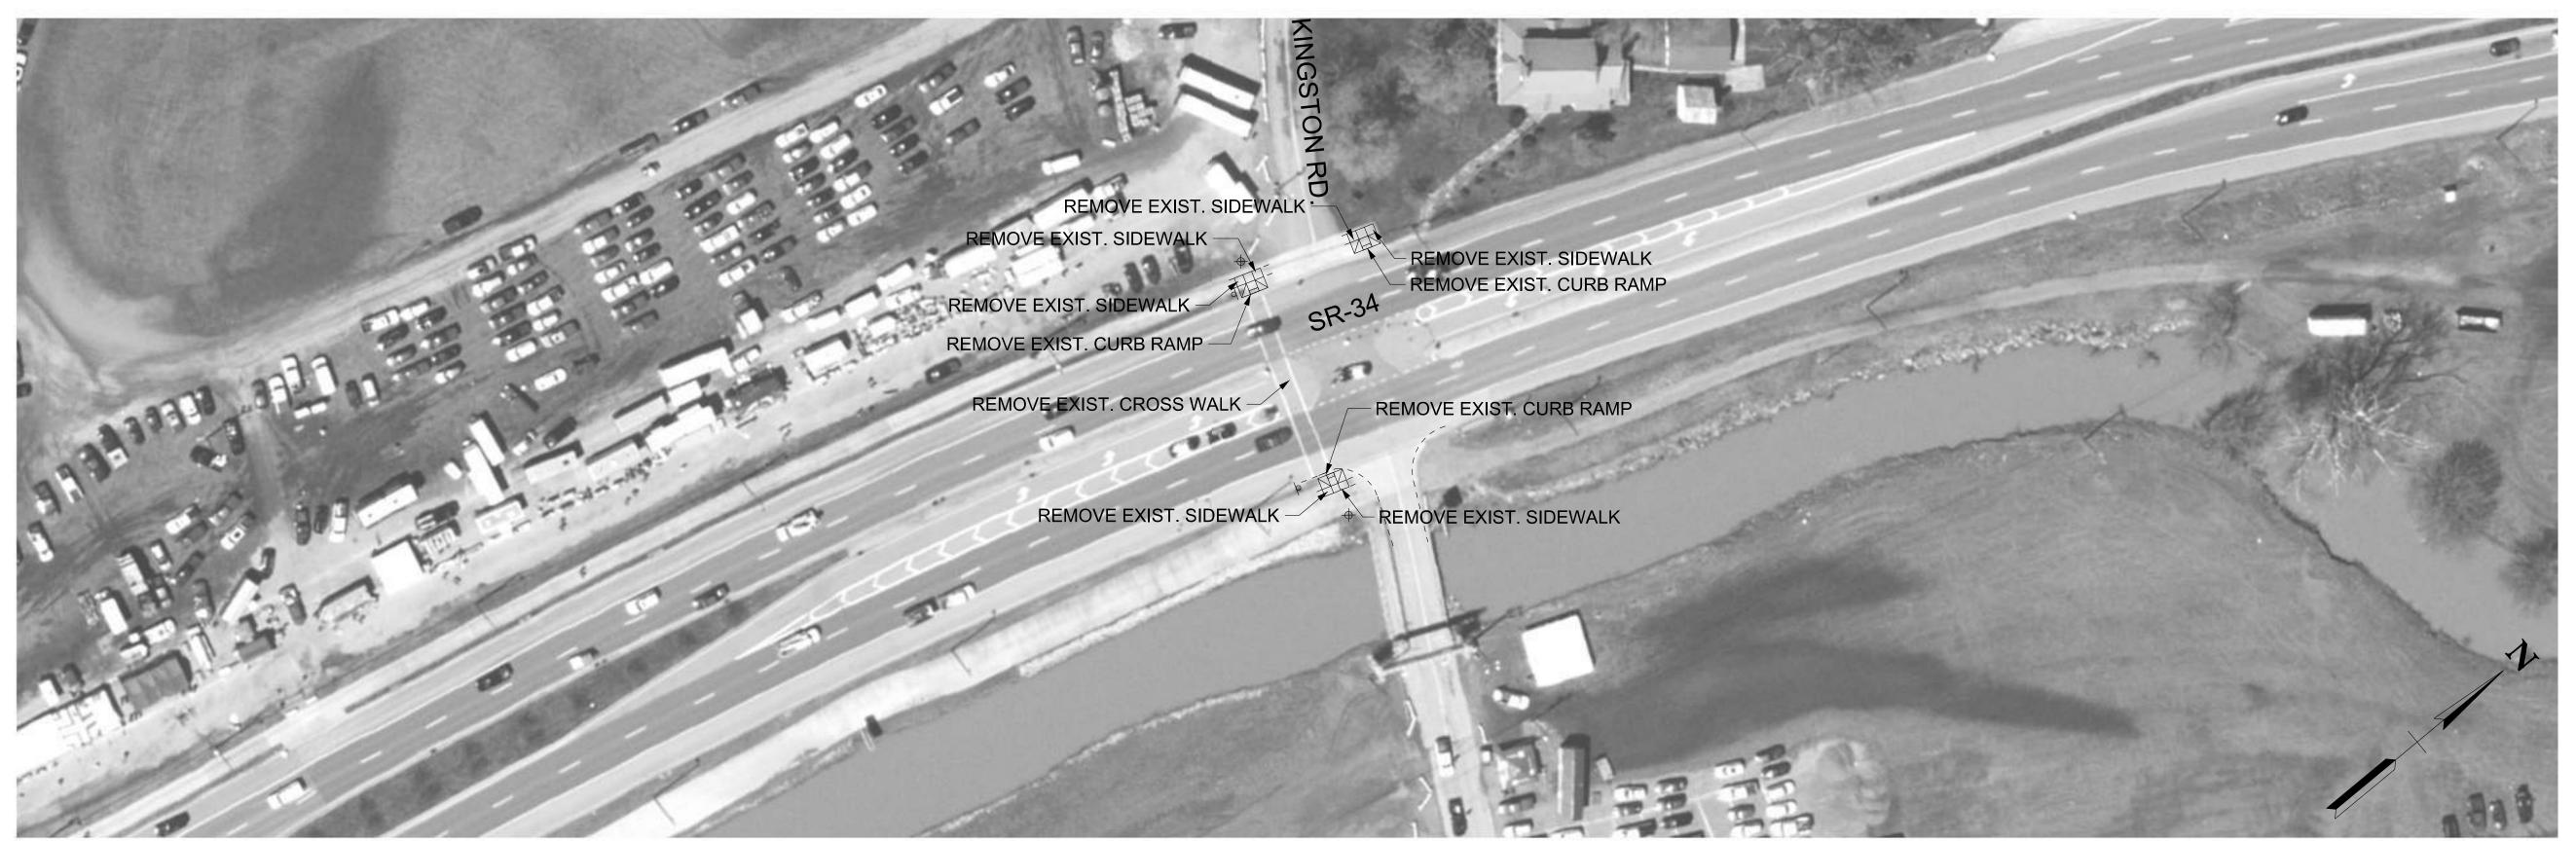

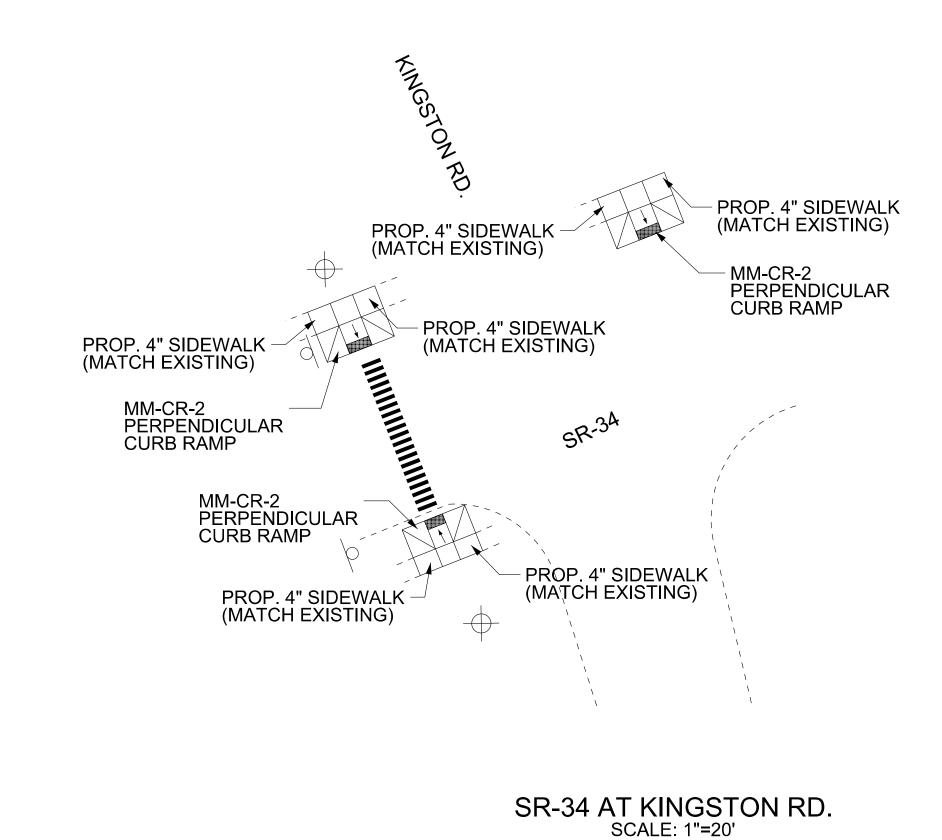

NOTE:

CONTRACTOR SHALL REMOVE ALL CONFLICTING PAVEMENT MARKINGS INCLUDING EXISTING CROSSWALKS AND STOP LINES.

PROPOSED CROSS WALKS, STOP LINES AND PAVEMENT

SHALL BE INSTALLED USING PLASTIC/THERMOPLASTIC PAVEMENT MARKINGS.

ALL UTILITY LOCATIONS SHOWN ON THESE PLANS ARE APPROXIMATE. THE CONTRACTOR SHALL FIELD LOCATE ALL UTILITIES PRIOR TO BEGINNING CONSTRUCTION.
CONTRACTOR SHALL TAKE CARE TO AVOID ALL EXISTING UTILITIES.

**EXISTING SIGN EXISTING FIRE HYDRANT** EXISTING WATER/GAS VALVE 🛛

**EXISTING MAIL BOX EXISTING MANHOLE** 

**EXISTING STORM INLET** EXISTING UTILITY POLE EXISTING LIGHT POLE

LEGEND

**EXISTING SIGNAL POLE** 

○-IPB--EXISTING PED PUSHBUTTON

⊕-⊕-⊕ EXISTING GUARDRAIL

--- ( EXISTING GUY WIRE EXISTING SIGNAL CONTROL EXISTING UTILITY BOX DETECTABLE WARNING SURFACE

\* \* \* EXISTING FENCE PROP. STOP LINE PROP. CROSS WALK PROP. LONGITUDINAL CROSS WALK

# TDOT REGION 1 DISTRICT 17 CURB RAMP IMPROVEMENTS

SR-34 LOG MILE 6.11 TO LOG MILE 11.60 **SULLIVAN COUNTY** 


STATE OF TENNESSEE DEPARTMENT OF TRANSPORTATION S.T.I.D.

LAYOUT

L.M. 10.05 TO L.M. 10.06

SCALE: 1"= 50'

SAFETY 2023 R1SVAR-F3-028

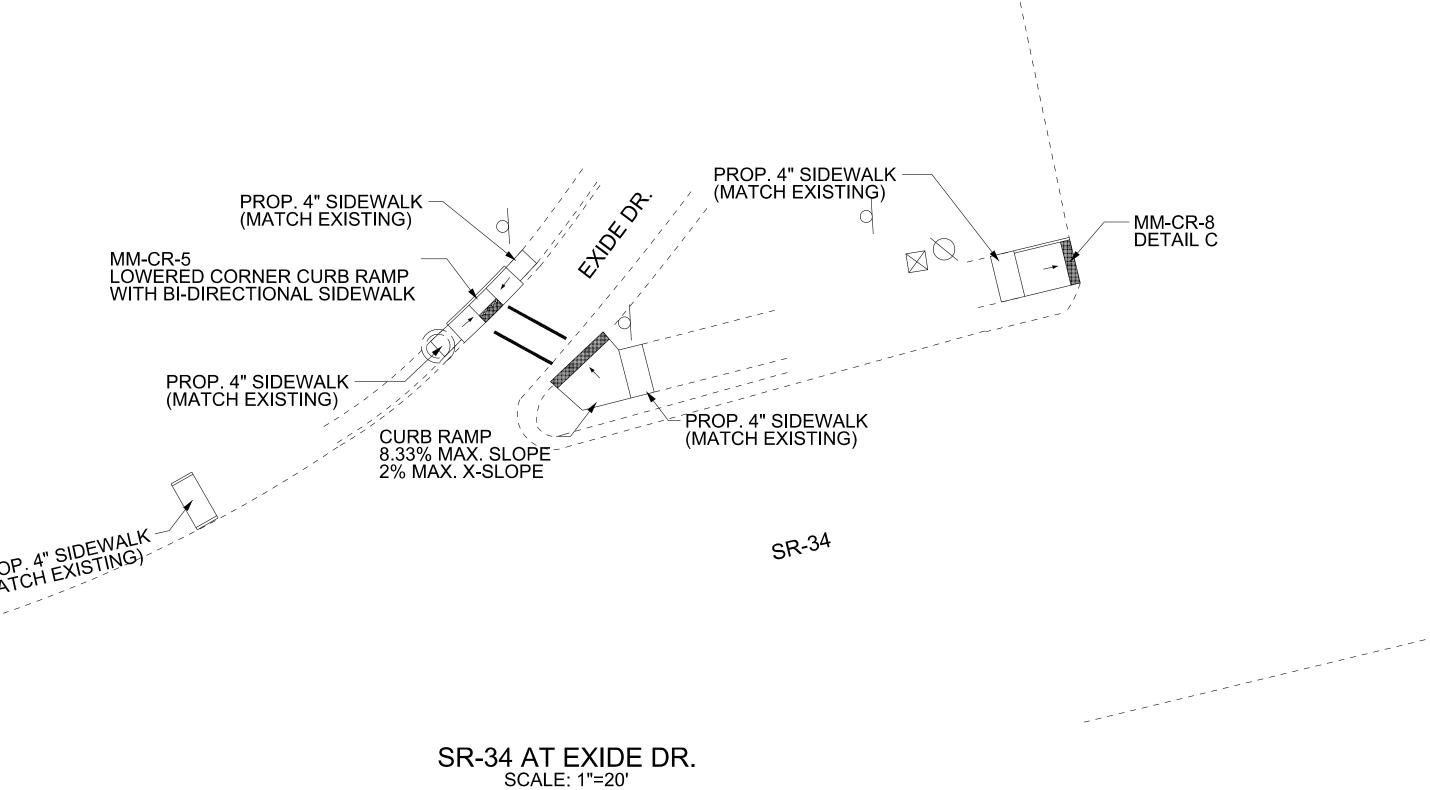

NOTE:

CONTRACTOR SHALL REMOVE ALL CONFLICTING PAVEMENT MARKINGS INCLUDING EXISTING CROSSWALKS AND STOP LINES.

PROPOSED CROSS WALKS, STOP LINES AND PAVEMENT SHALL BE INSTALLED USING PLASTIC/THERMOPLASTIC PAVEMENT MARKINGS.

ALL UTILITY LOCATIONS SHOWN ON THESE PLANS ARE APPROXIMATE. THE CONTRACTOR SHALL FIELD LOCATE ALL UTILITIES PRIOR TO BEGINNING CONSTRUCTION. CONTRACTOR SHALL TAKE CARE TO AVOID ALL EXISTING UTILITIES.

**EXISTING SIGN** 

EXISTING FIRE HYDRANT EXISTING WATER/GAS VALVE 🛛

**EXISTING MAIL BOX EXISTING MANHOLE** 

**EXISTING STORM INLET EXISTING UTILITY POLE** 

LEGEND --- ( EXISTING GUY WIRE

**EXISTING SIGNAL POLE** 

○-IPB--EXISTING PED PUSHBUTTON

▽─▽─▽ EXISTING GUARDRAIL

\* \* \* EXISTING FENCE EXISTING SIGNAL CONTROL EXISTING UTILITY BOX DETECTABLE WARNING SURFACE

PROP. STOP LINE PROP. CROSS WALK PROP. LONGITUDINAL CROSS WALK

# TDOT REGION 1 DISTRICT 17 CURB RAMP IMPROVEMENTS

SR-34 LOG MILE 6.11 TO LOG MILE 11.60 SULLIVAN COUNTY


STATE OF TENNESSEE DEPARTMENT OF TRANSPORTATION S.T.I.D.

LAYOUT

L.M. 10.14 TO L.M. 10.19

SCALE: 1"= 50'



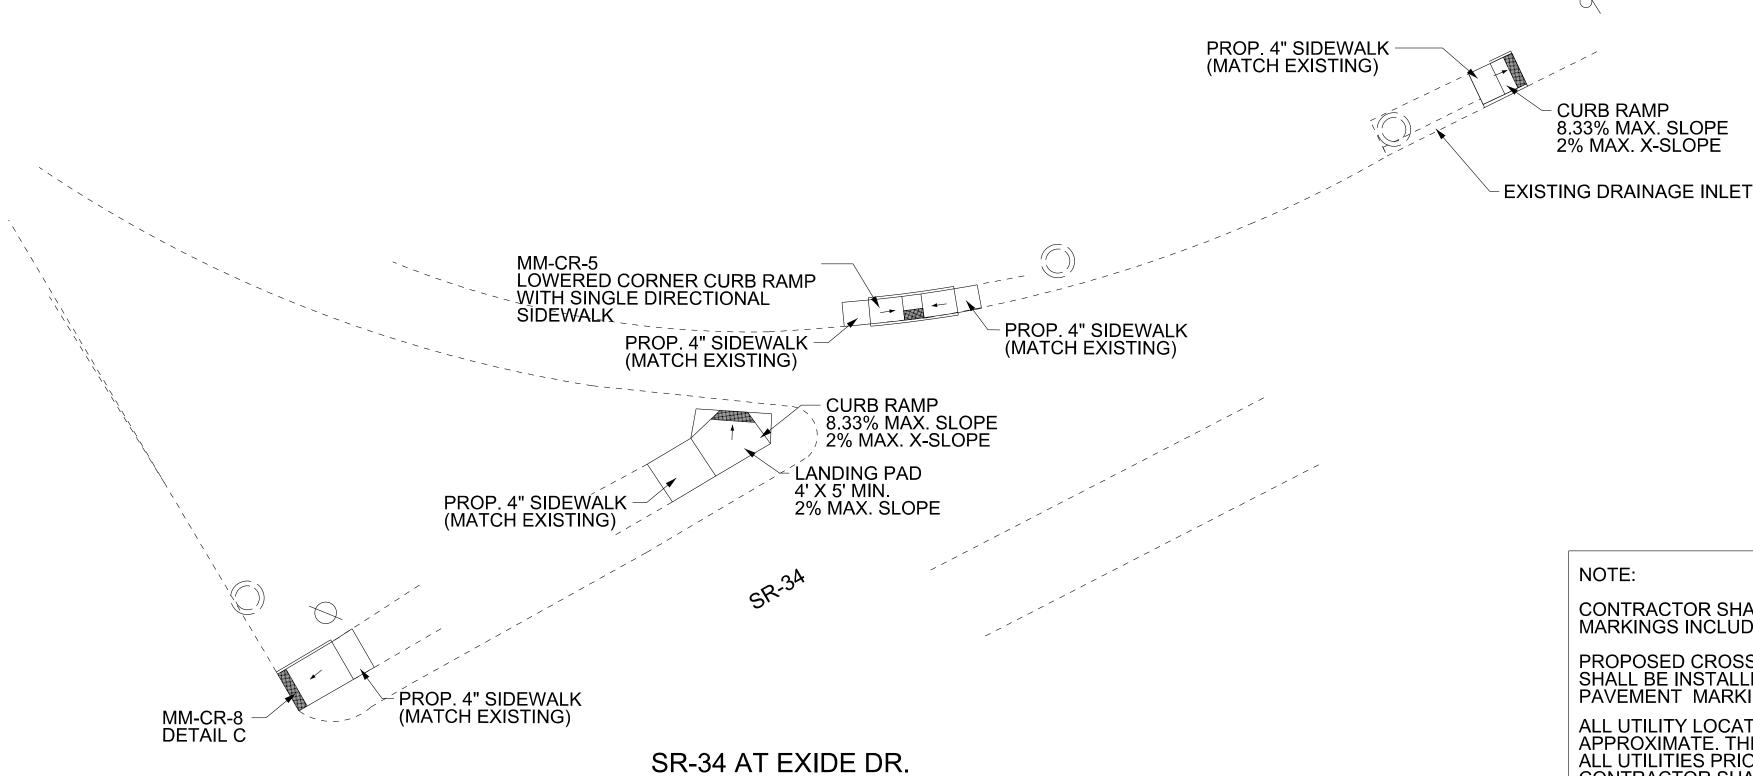

SCALE: 1"=20'

CONTRACTOR SHALL REMOVE ALL CONFLICTING PAVEMENT MARKINGS INCLUDING EXISTING CROSSWALKS AND STOP LINES.

PROPOSED CROSS WALKS, STOP LINES AND PAVEMENT SHALL BE INSTALLED USING PLASTIC/THERMOPLASTIC PAVEMENT MARKINGS.

ALL UTILITY LOCATIONS SHOWN ON THESE PLANS ARE APPROXIMATE. THE CONTRACTOR SHALL FIELD LOCATE ALL UTILITIES PRIOR TO BEGINNING CONSTRUCTION. CONTRACTOR SHALL TAKE CARE TO AVOID ALL EXISTING UTILITIES.

# TDOT REGION 1 DISTRICT 17 CURB RAMP IMPROVEMENTS

SR-34 LOG MILE 6.11 TO LOG MILE 11.60 **SULLIVAN COUNTY** 

DEPARTMENT OF TRANSPORTATION S.T.I.D.

STATE OF TENNESSEE

LAYOUT L.M. 10.20 TO L.M. 10.25

SCALE: 1"= 50'

**EXISTING SIGN** 

**EXISTING FIRE HYDRANT** EXISTING WATER/GAS VALVE 🛛 **EXISTING MAIL BOX** 

**EXISTING MANHOLE** 

**EXISTING UTILITY POLE** 

**EXISTING STORM INLET** 

LEGEND --- ( EXISTING GUY WIRE EXISTING SIGNAL CONTROL

EXISTING UTILITY BOX DETECTABLE WARNING SURFACE \* \* \* EXISTING FENCE

PROP. STOP LINE

PROP. CROSS WALK

PROP. LONGITUDINAL CROSS WALK

▽─▽─▽ EXISTING GUARDRAIL

**EXISTING SIGNAL POLE** 

○-IPB--EXISTING PED PUSHBUTTON